



								PENINSULA CORRIDOR JOINT PO	WERS BOARD	ENGINEERING STANDARD DRAWINGS	CADD FILE NAME: SD-3001A
								APPROVED BY:	Caltuair	STATIONS AND FACILITIES FURNITURE AND SIGN LOCATION PLAN	REV: EDITION: FIFTH
	010126		FIFTH EDITION					ven znang	Caltrain	AT-GRADE OUTBOARD PLATFORMS	NTS STANDARD DRAWING NO.:
REV	DATE	BY CHK	APP	DESCRIPTION	REV DATE	BY CHK	APP	DIRECTOR, ENGINEERING		BOMBARDIER TRAINSETS	SD-3001A

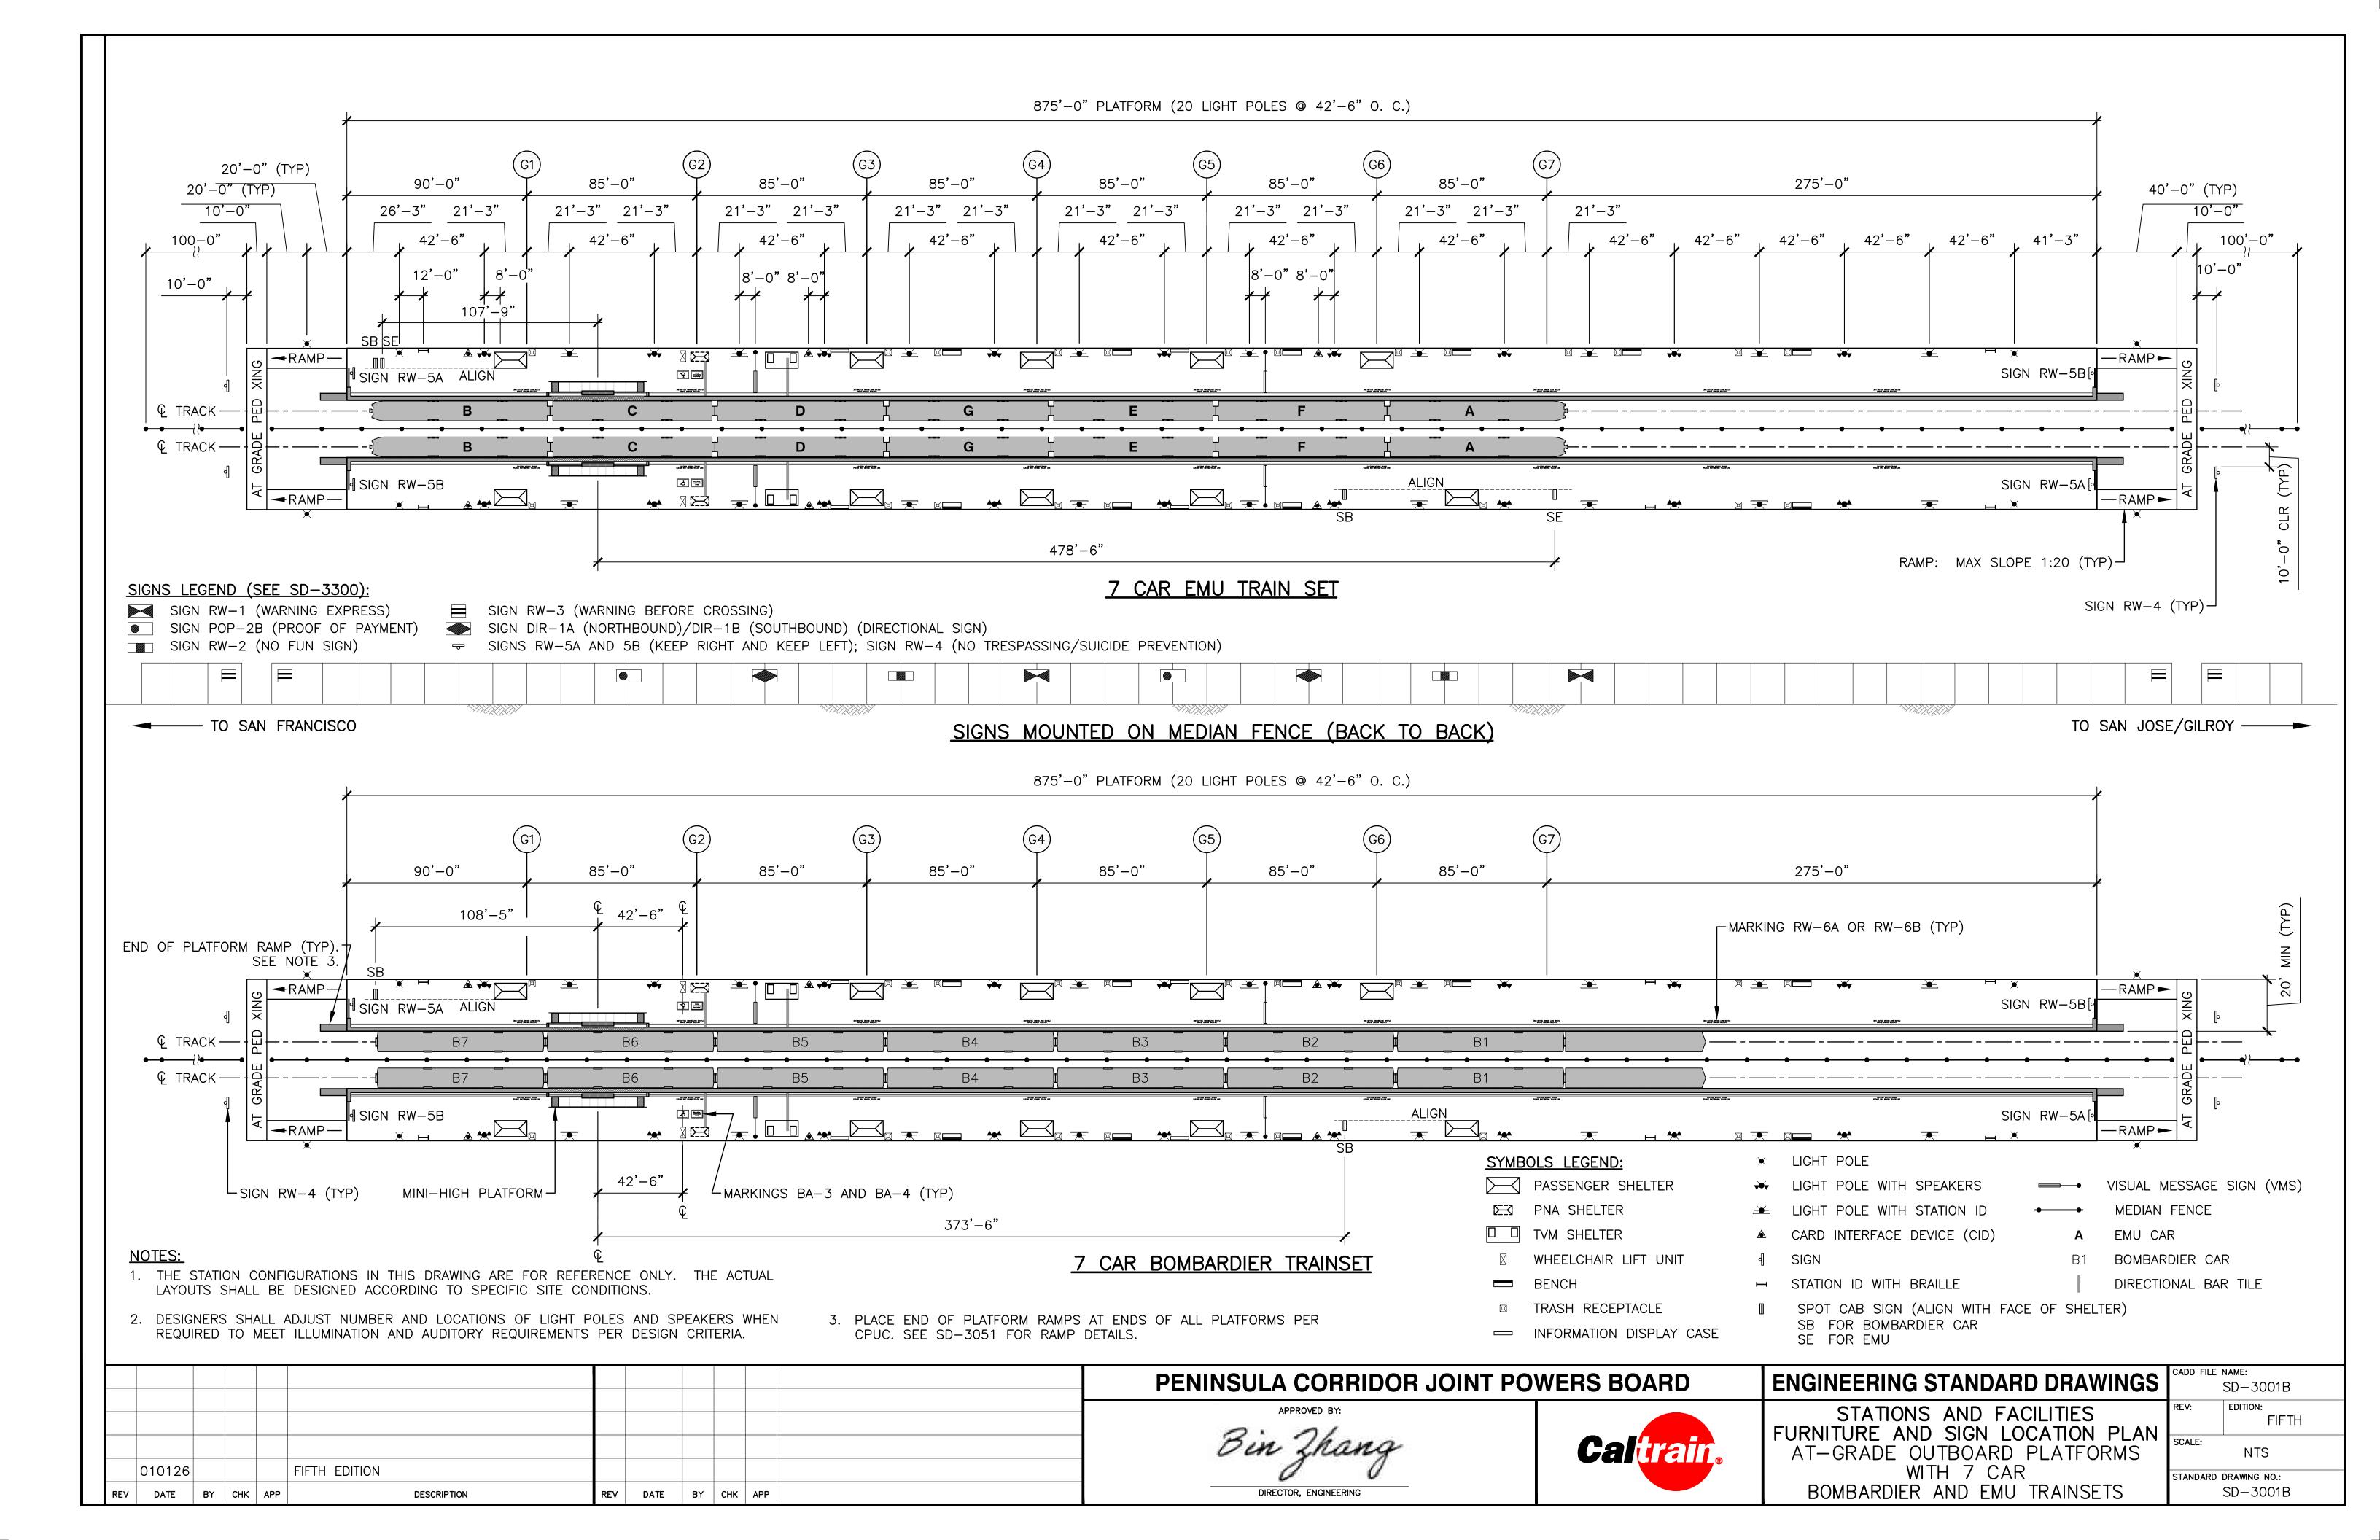

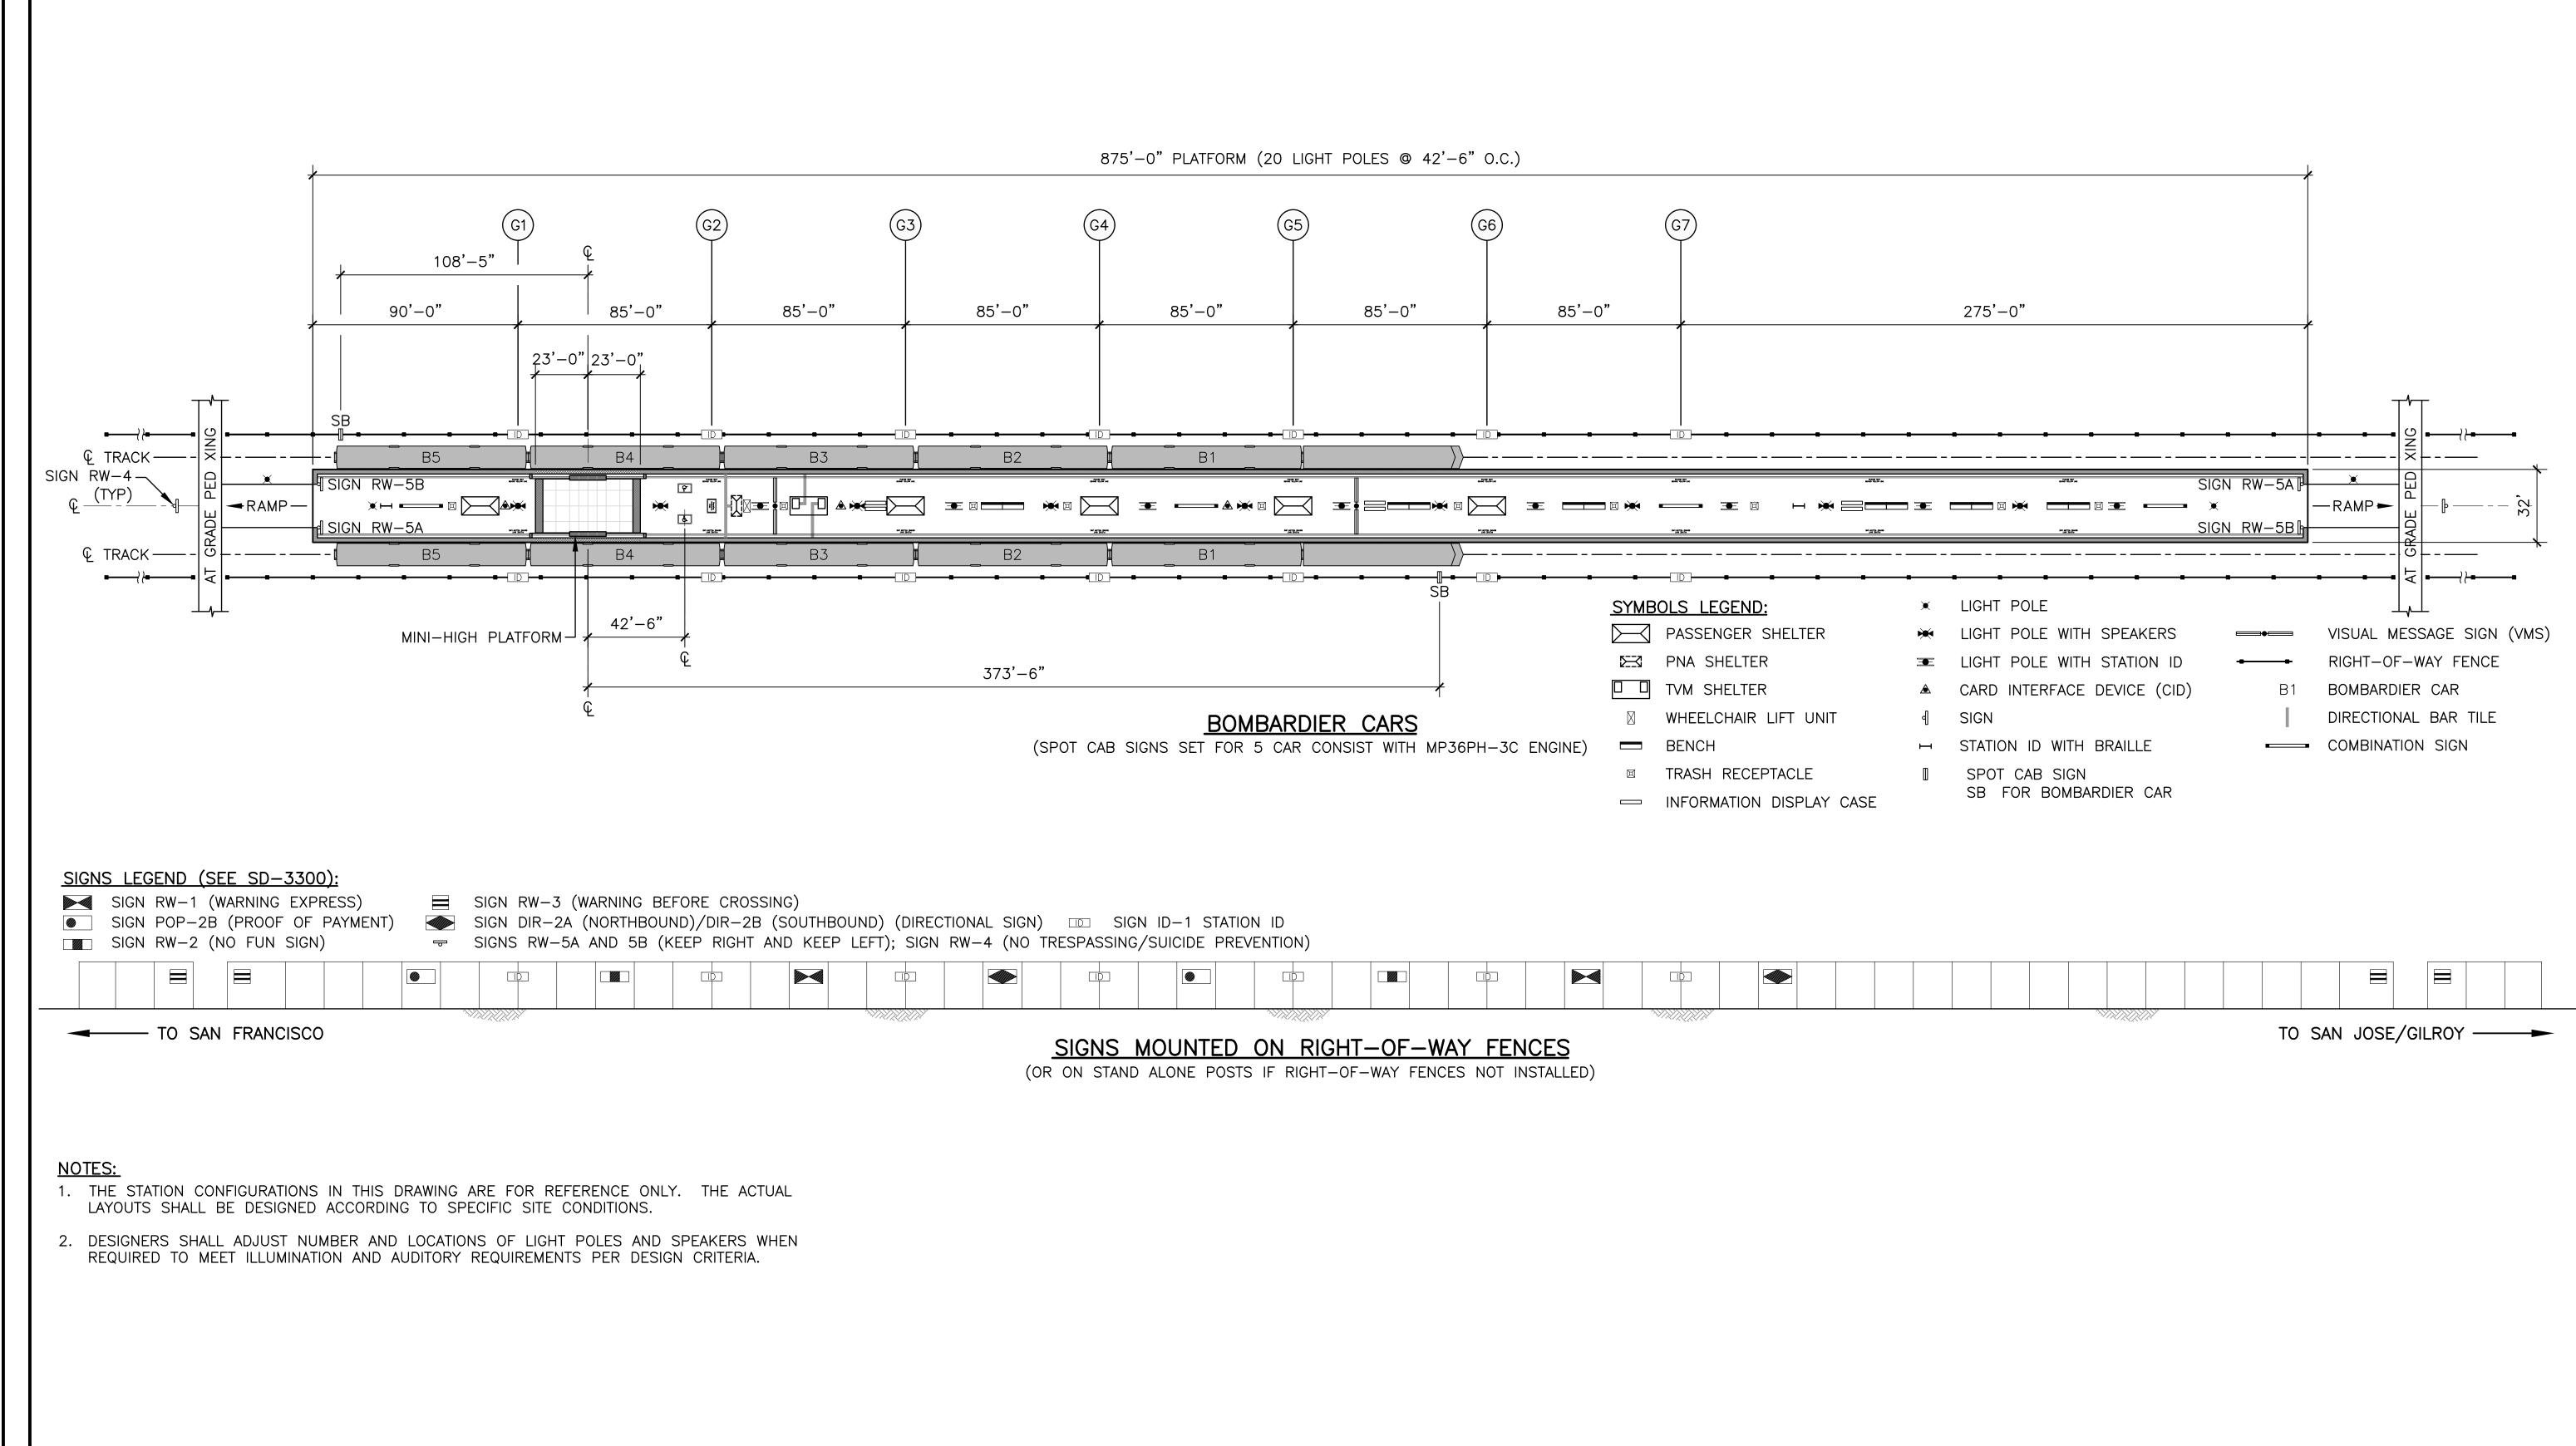

PENINSULA CORRIDOR JOINT POWERS BOARD

ENGINEERING STANDARD DRAWINGS

CADD FILE NAME:
SD-3002A

APPROVED BY:

Bin Zhang

O10126 | FIFTH EDITION


REV DATE BY CHK APP DESCRIPTION REV DATE BY CHK APP


PENINSULA CORRIDOR JOINT POWERS BOARD

ENGINEERING STANDARD DRAWINGS


STATIONS AND FACILITIES
FURNITURE AND SIGN LOCATION PLAN
AT-GRADE CENTER ISLAND PLATFORM
WITH 5 CAR
BOMBARDIER TRAINSETS

FINANDARD DRAWING NO:
STANDARD DRAWING NO:
SD-3002A

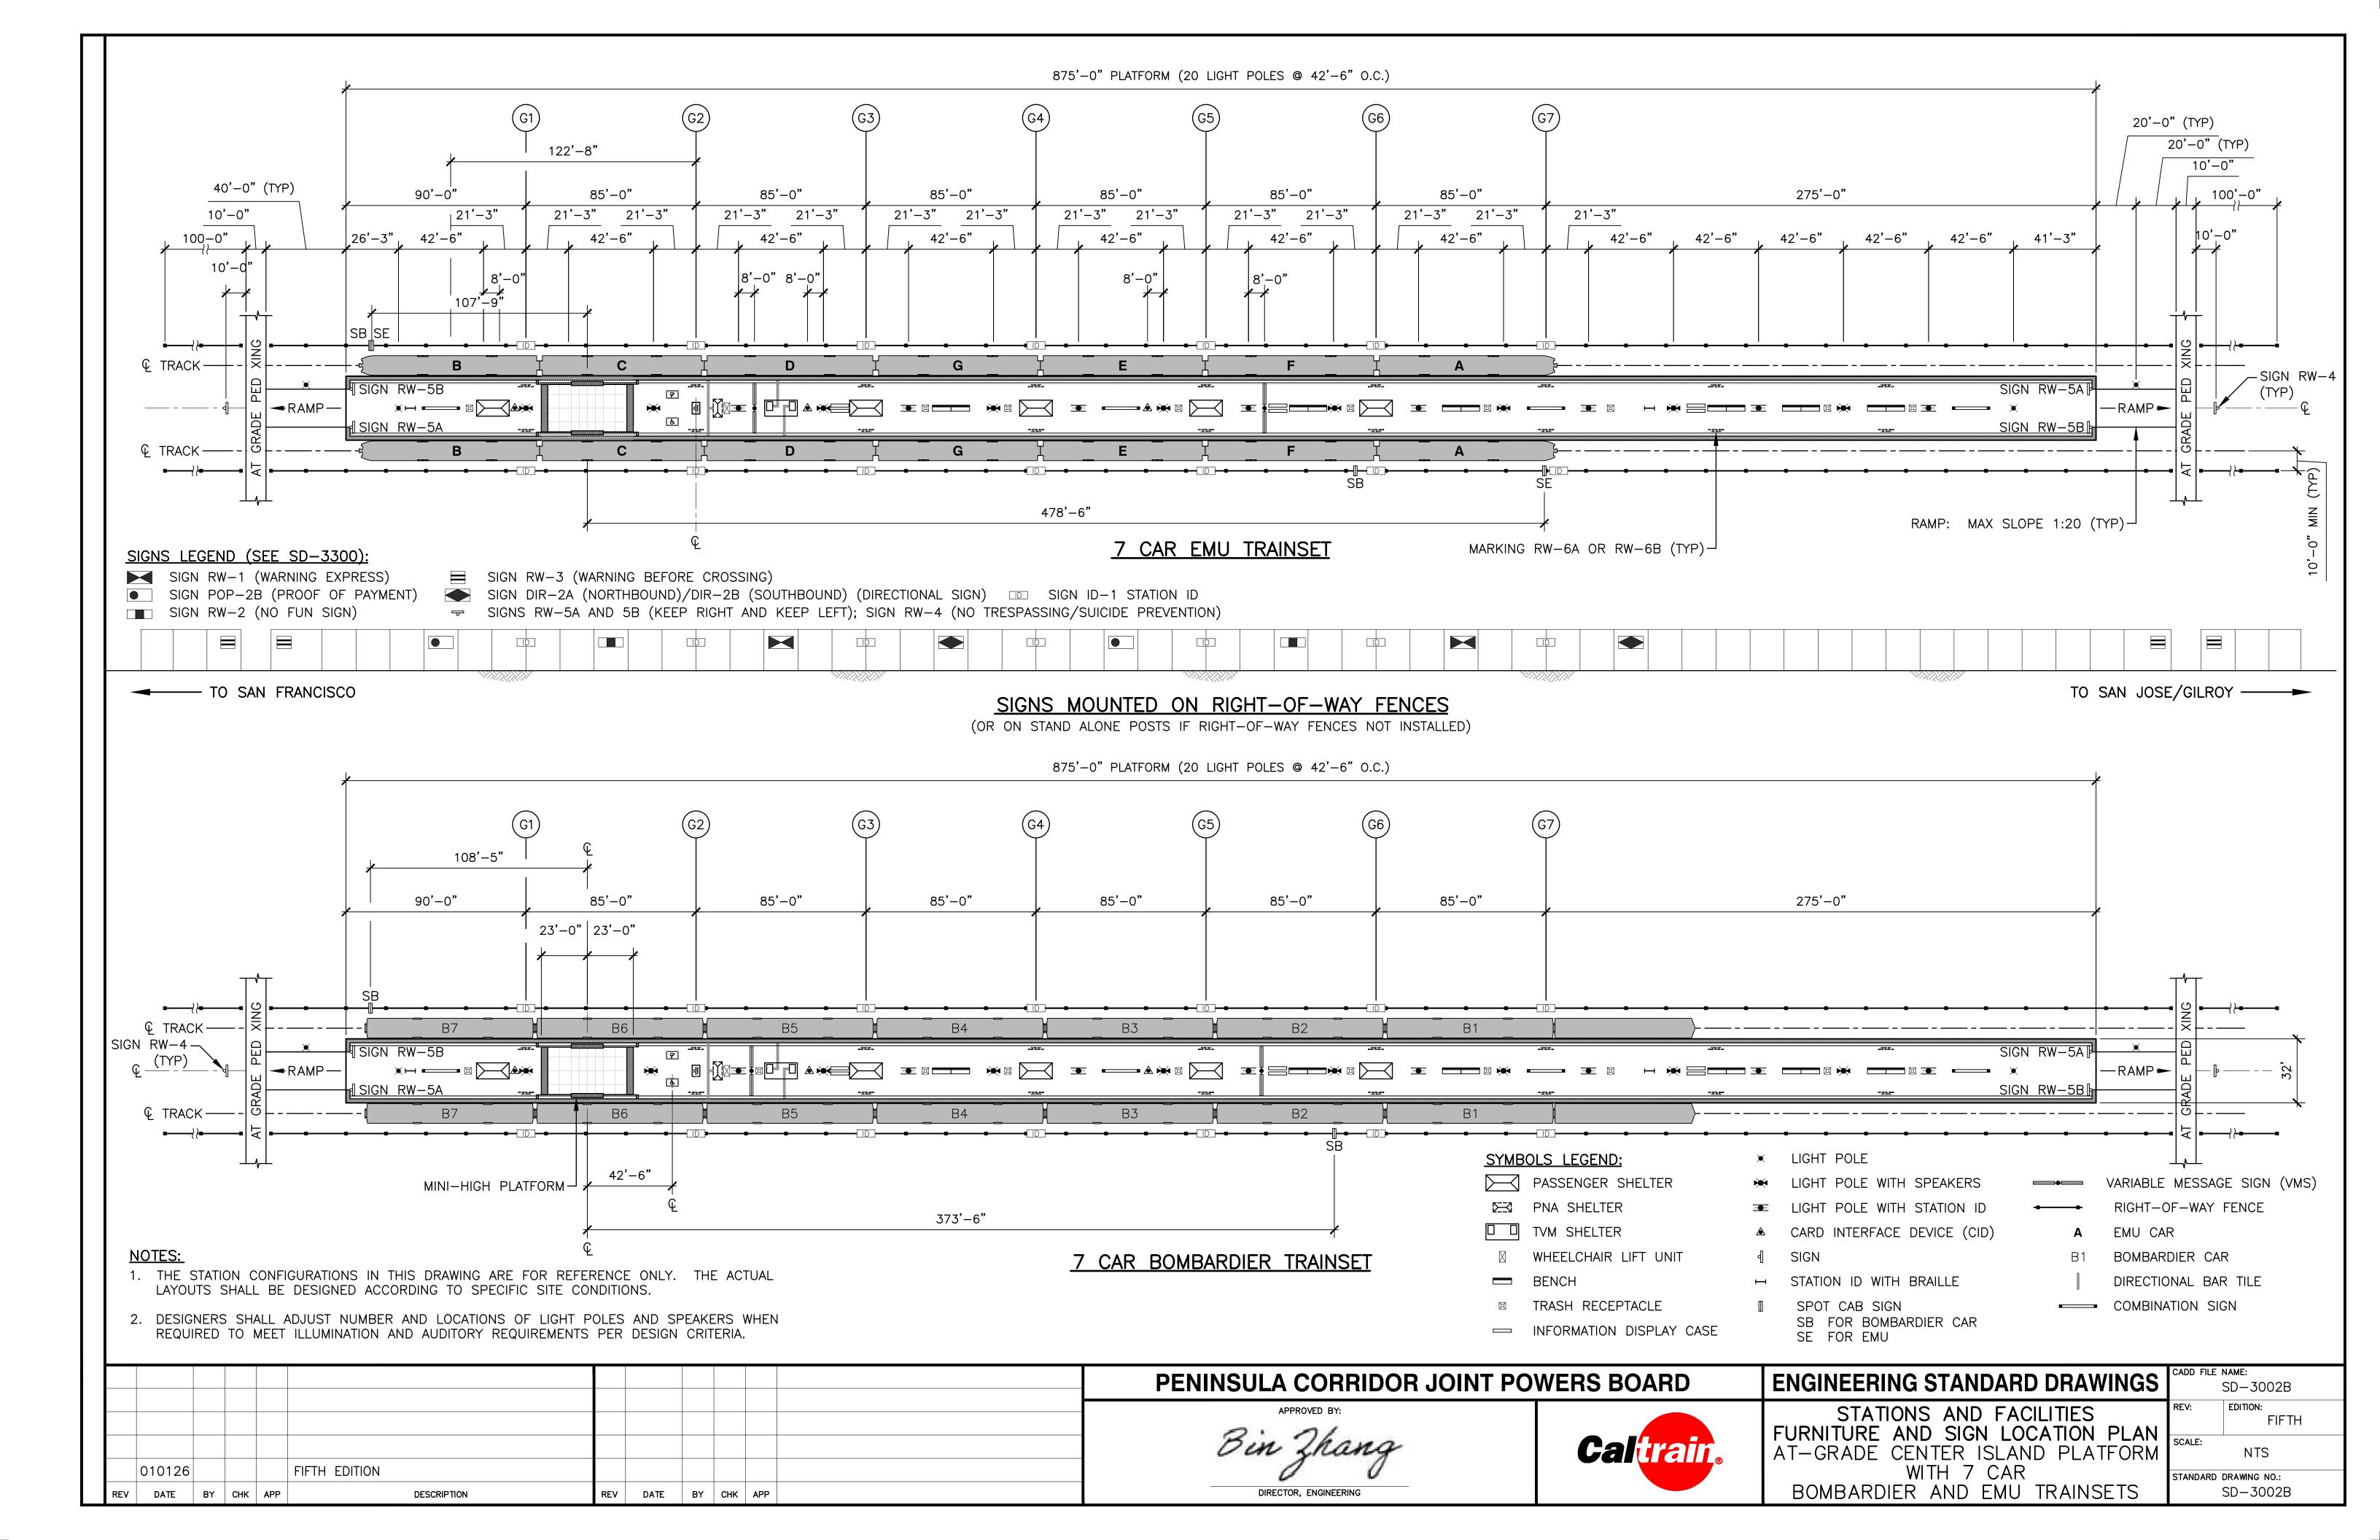

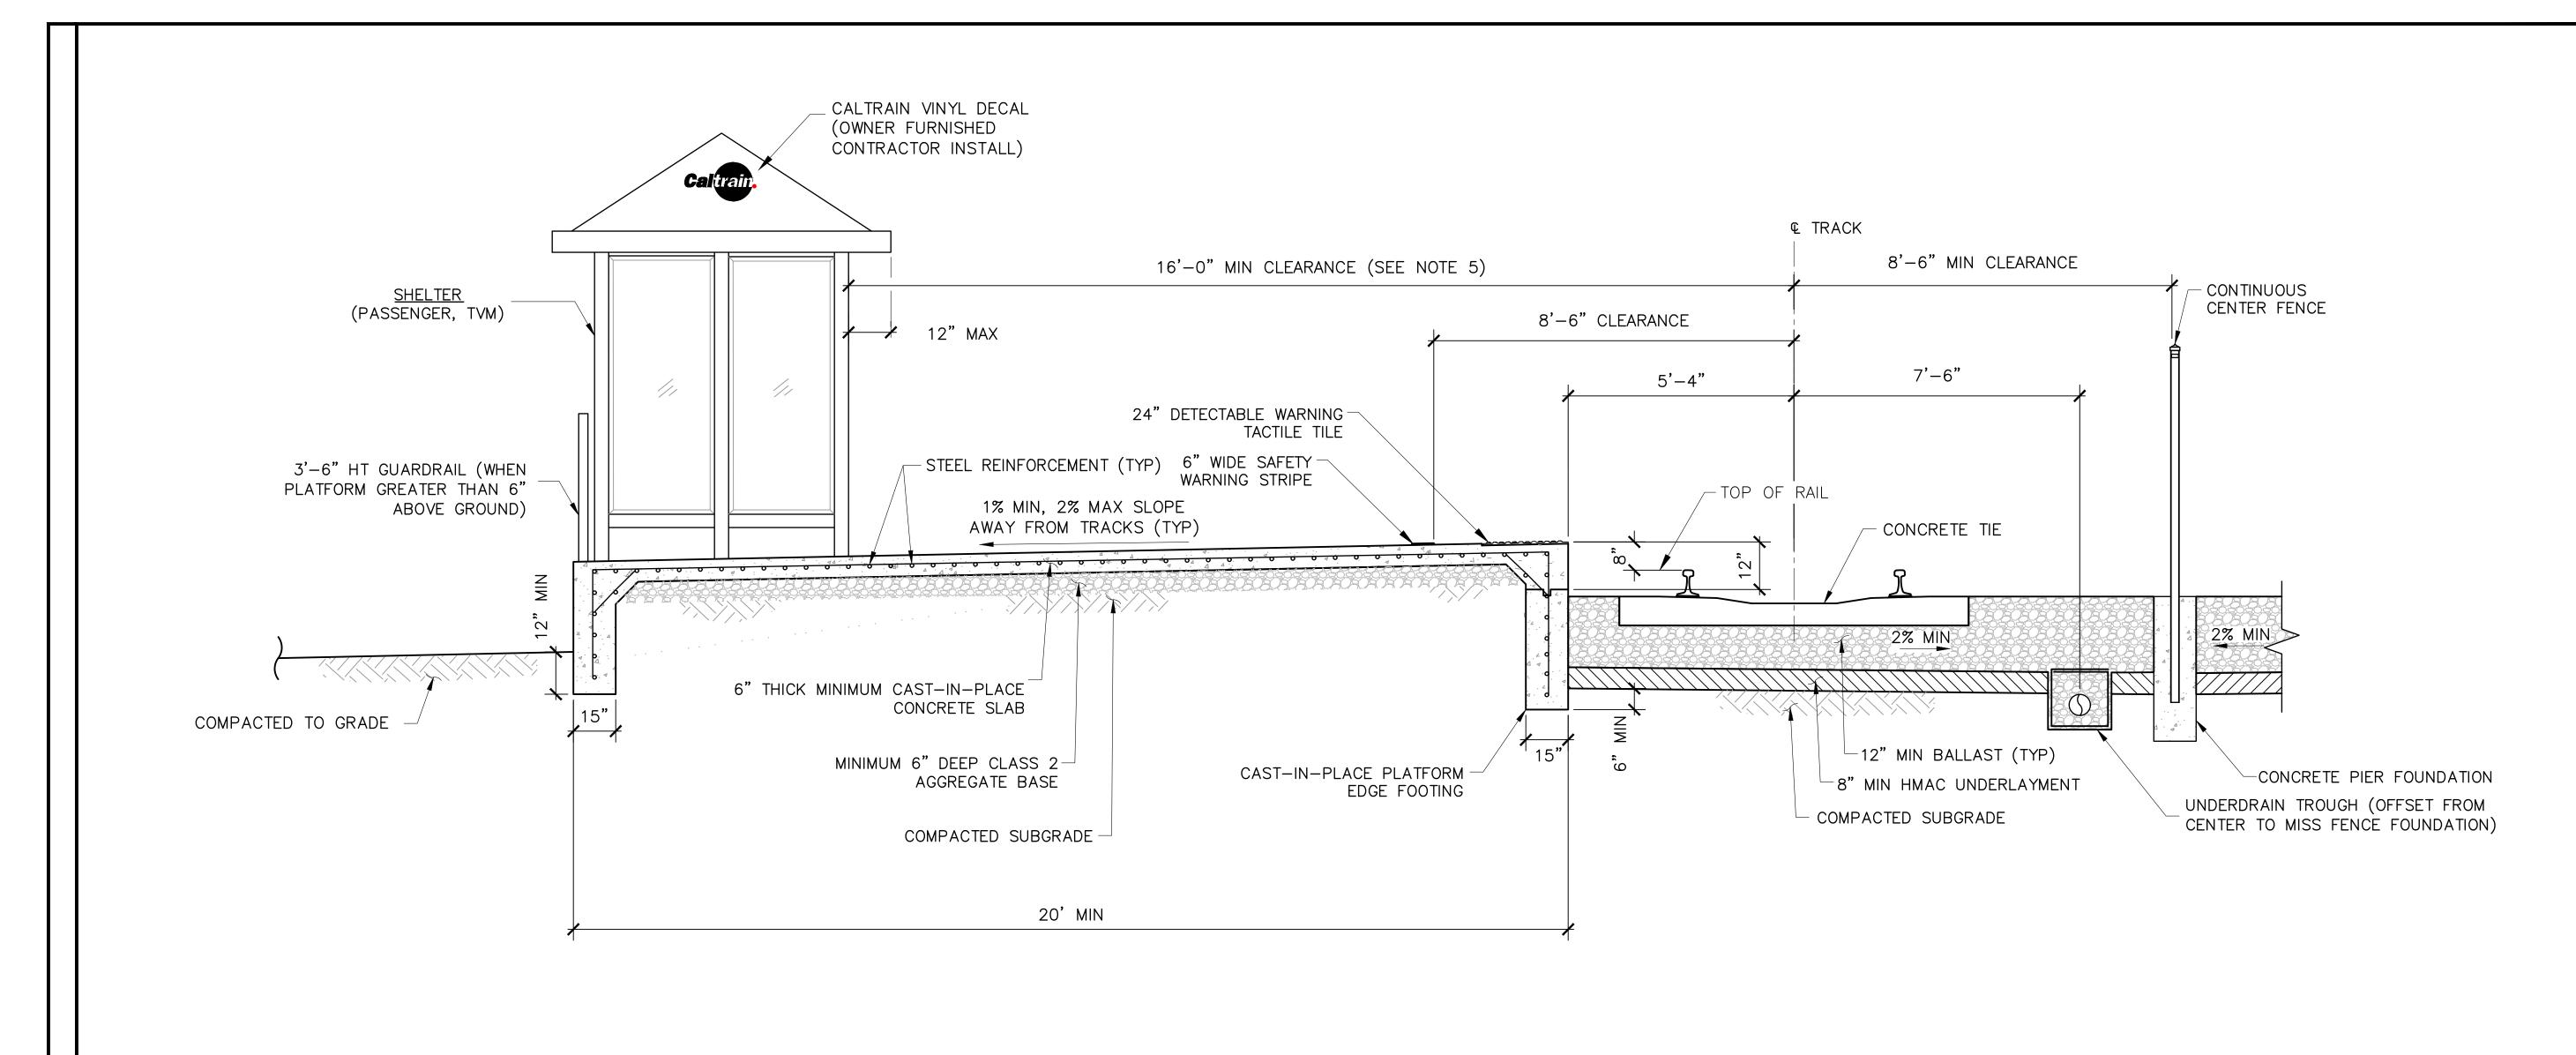

- 1. PLATFORMS SHALL SLOPE AWAY FROM THE TRACKS TO ELIMINATE ROLLING EFFECTS (SUCH AS WHEELCHAIRS) TOWARDS THE TRACKS AND TO REDUCE WATER DRAINING INTO THE TRACKS.
- 2. STEEL REINFORCEMENT FOR PLATFORM SLABS AND FOOTING IS FOR ILLUSTRATION ONLY. DESIGNER SHALL PROVIDE DETAILS OF THE REQUIRED STEEL REINFORCEMENT FOR THE PLATFORM FOOTING AND SLAB.
- 3. SEE SD-8101 FOR UNDERDRAIN DETAILS.
- 4. SEE SD-3601 AND SD-3602 FOR FENCE/GUARDRAIL AND FOUNDATION DETAILS.
- 5. THIS MINIMUM CLEARANCE SHALL BE MAINTAINED FOR SAFETY AND FOR TRAFFIC CIRCULATION, AND ALSO APPLIES TO STAIRS, ELEVATORS AND ESCALATORS.

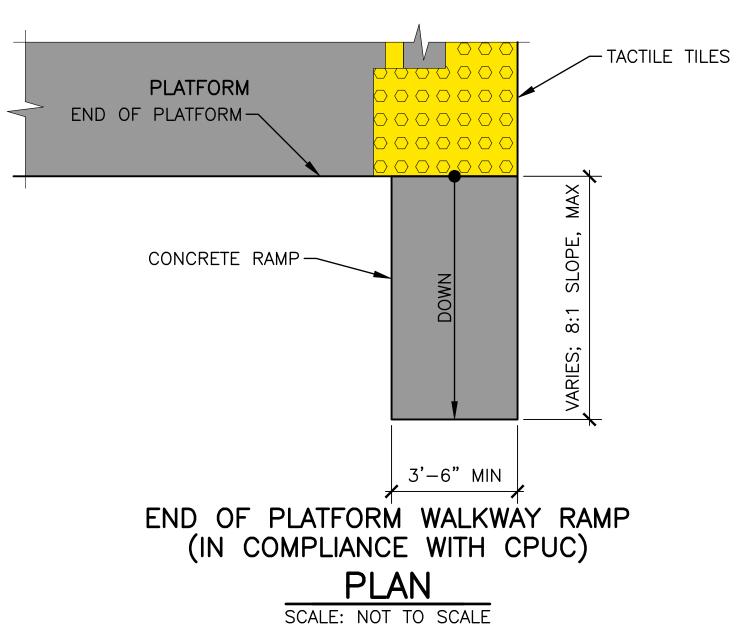


	010126			FIFTH EDITION							
REV	DATE	BY	СНК	APP	DESCRIPTION	REV	DATE	BY	СНК	APP	

PENINSULA CORRIDOR JOINT POWERS BOARD DIRECTOR, ENGINEERING





ENGINEERING STANDARD DRAWINGS	CADD FILE	NAME: SD-3051
STATIONS AND FACILITIES	REV:	EDITION: FIFTH
PASSENGER BOARDING AREAS TYPICAL SECTIONS	SCALE:	NTS
OUTBOARD PLATFORM	STANDARD	drawing no.: SD-3051

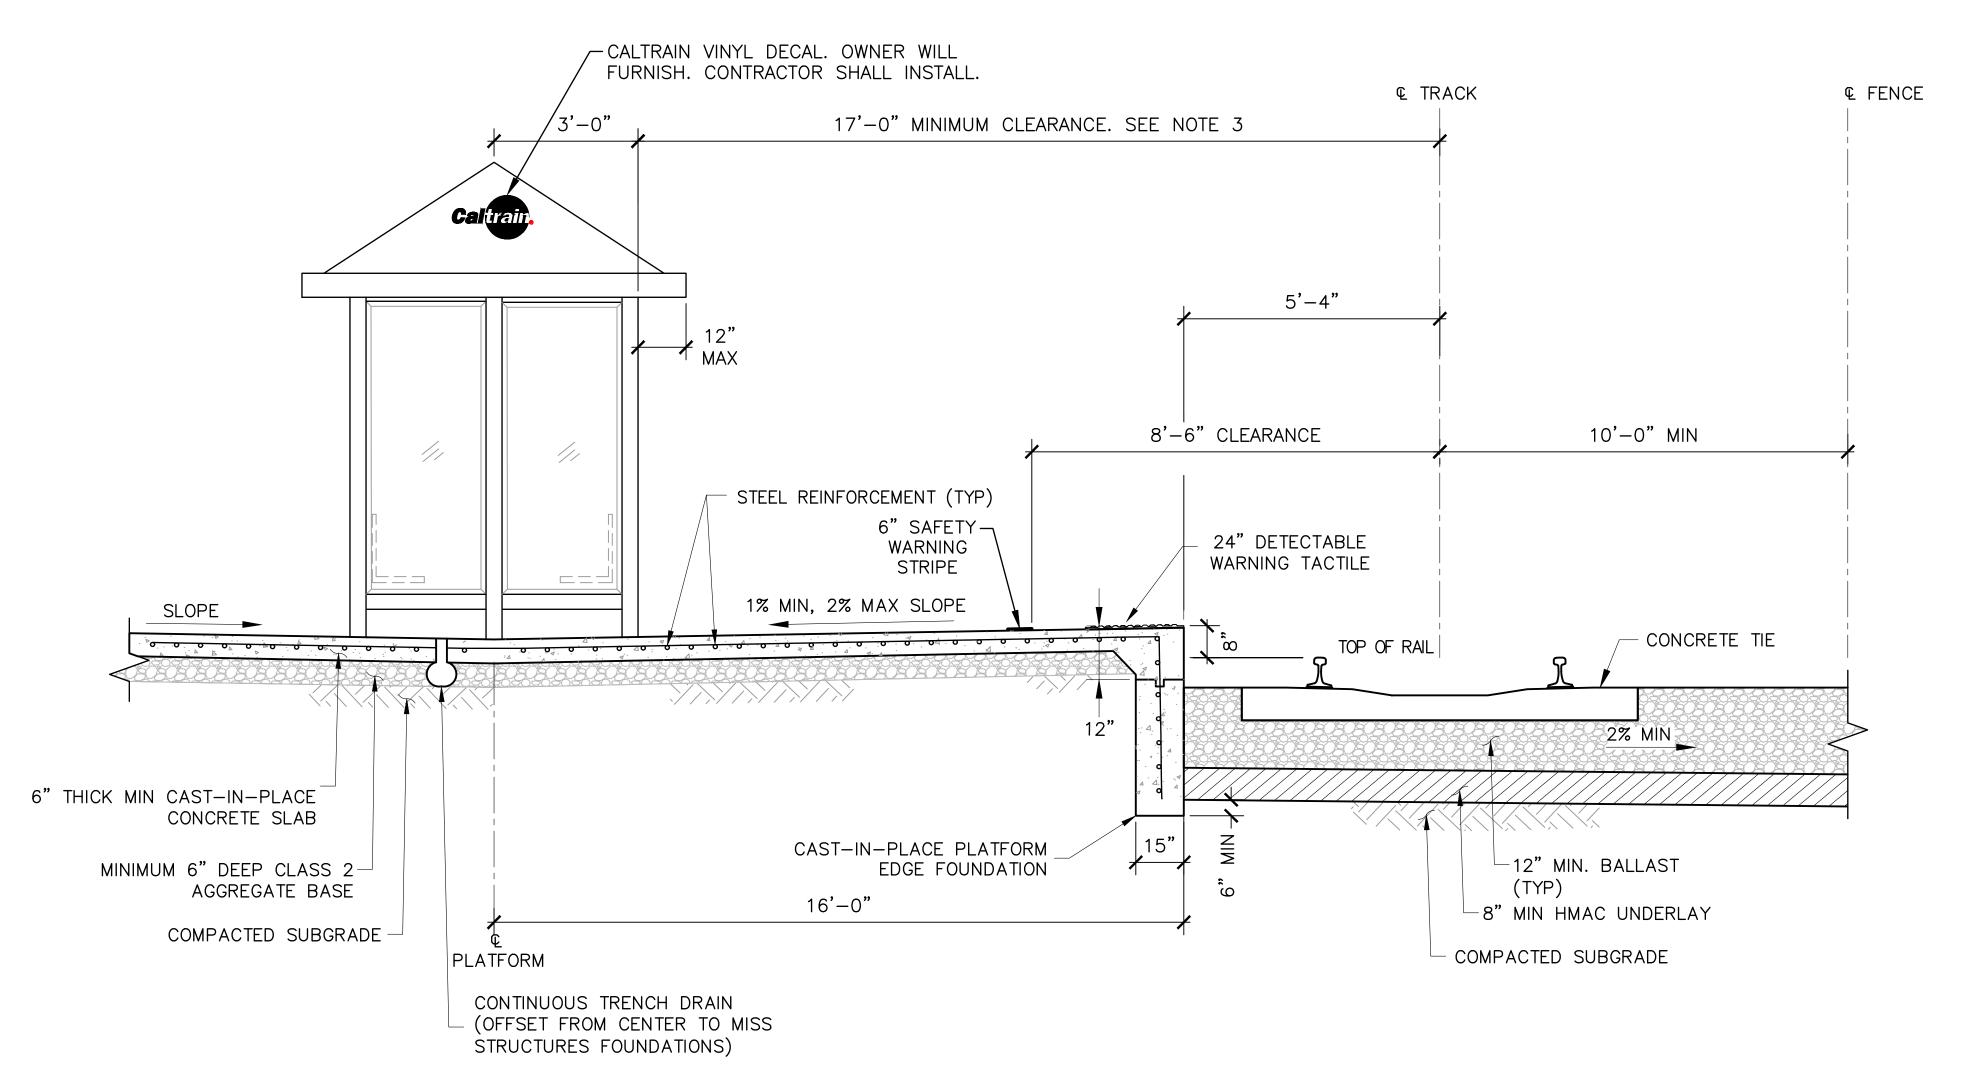


- 1. PLATFORMS SHALL SLOPE AWAY FROM THE TRACKS TO ELIMINATE ROLLING EFFECTS (SUCH AS WHEELCHAIRS) TOWARDS THE TRACKS AND TO REDUCE WATER DRAINING INTO THE TRACKS.
- 2. STEEL REINFORCEMENT FOR PLATFORM SLABS AND FOOTING IS FOR ILLUSTRATION ONLY. DESIGNER SHALL PROVIDE DETAILS OF THE REQUIRED STEEL REINFORCEMENT FOR THE PLATFORM FOOTING AND SLAB.
- 3. THIS MINIMUM CLEARANCE SHALL BE MAINTAINED FOR SAFETY AND FOR TRAFFIC CIRCULATION, AND ALSO APPLIES TO STAIRS, ELEVATORS AND ESCALATORS.
- 4. STATION FURNITURE (BENCHES, TRASH RECEPTACLES) SHALL BE PLACED AT MID WIDTH OF PLATFORM.


	PENINSULA CORRIDOR JOINT PO	WERS BOARD	ENGINEERING STANDARD DRAWINGS	CADD FILE NAME: SD-3052
010126	Bin Zhang DIRECTOR, ENGINEERING	Caltrain	STATIONS AND FACILITIES PASSENGER BOARDING AREAS TYPICAL SECTIONS CENTER ISLAND PLATFORM	REV: EDITION: FIFTH SCALE: NTS STANDARD DRAWING NO.: SD-3052

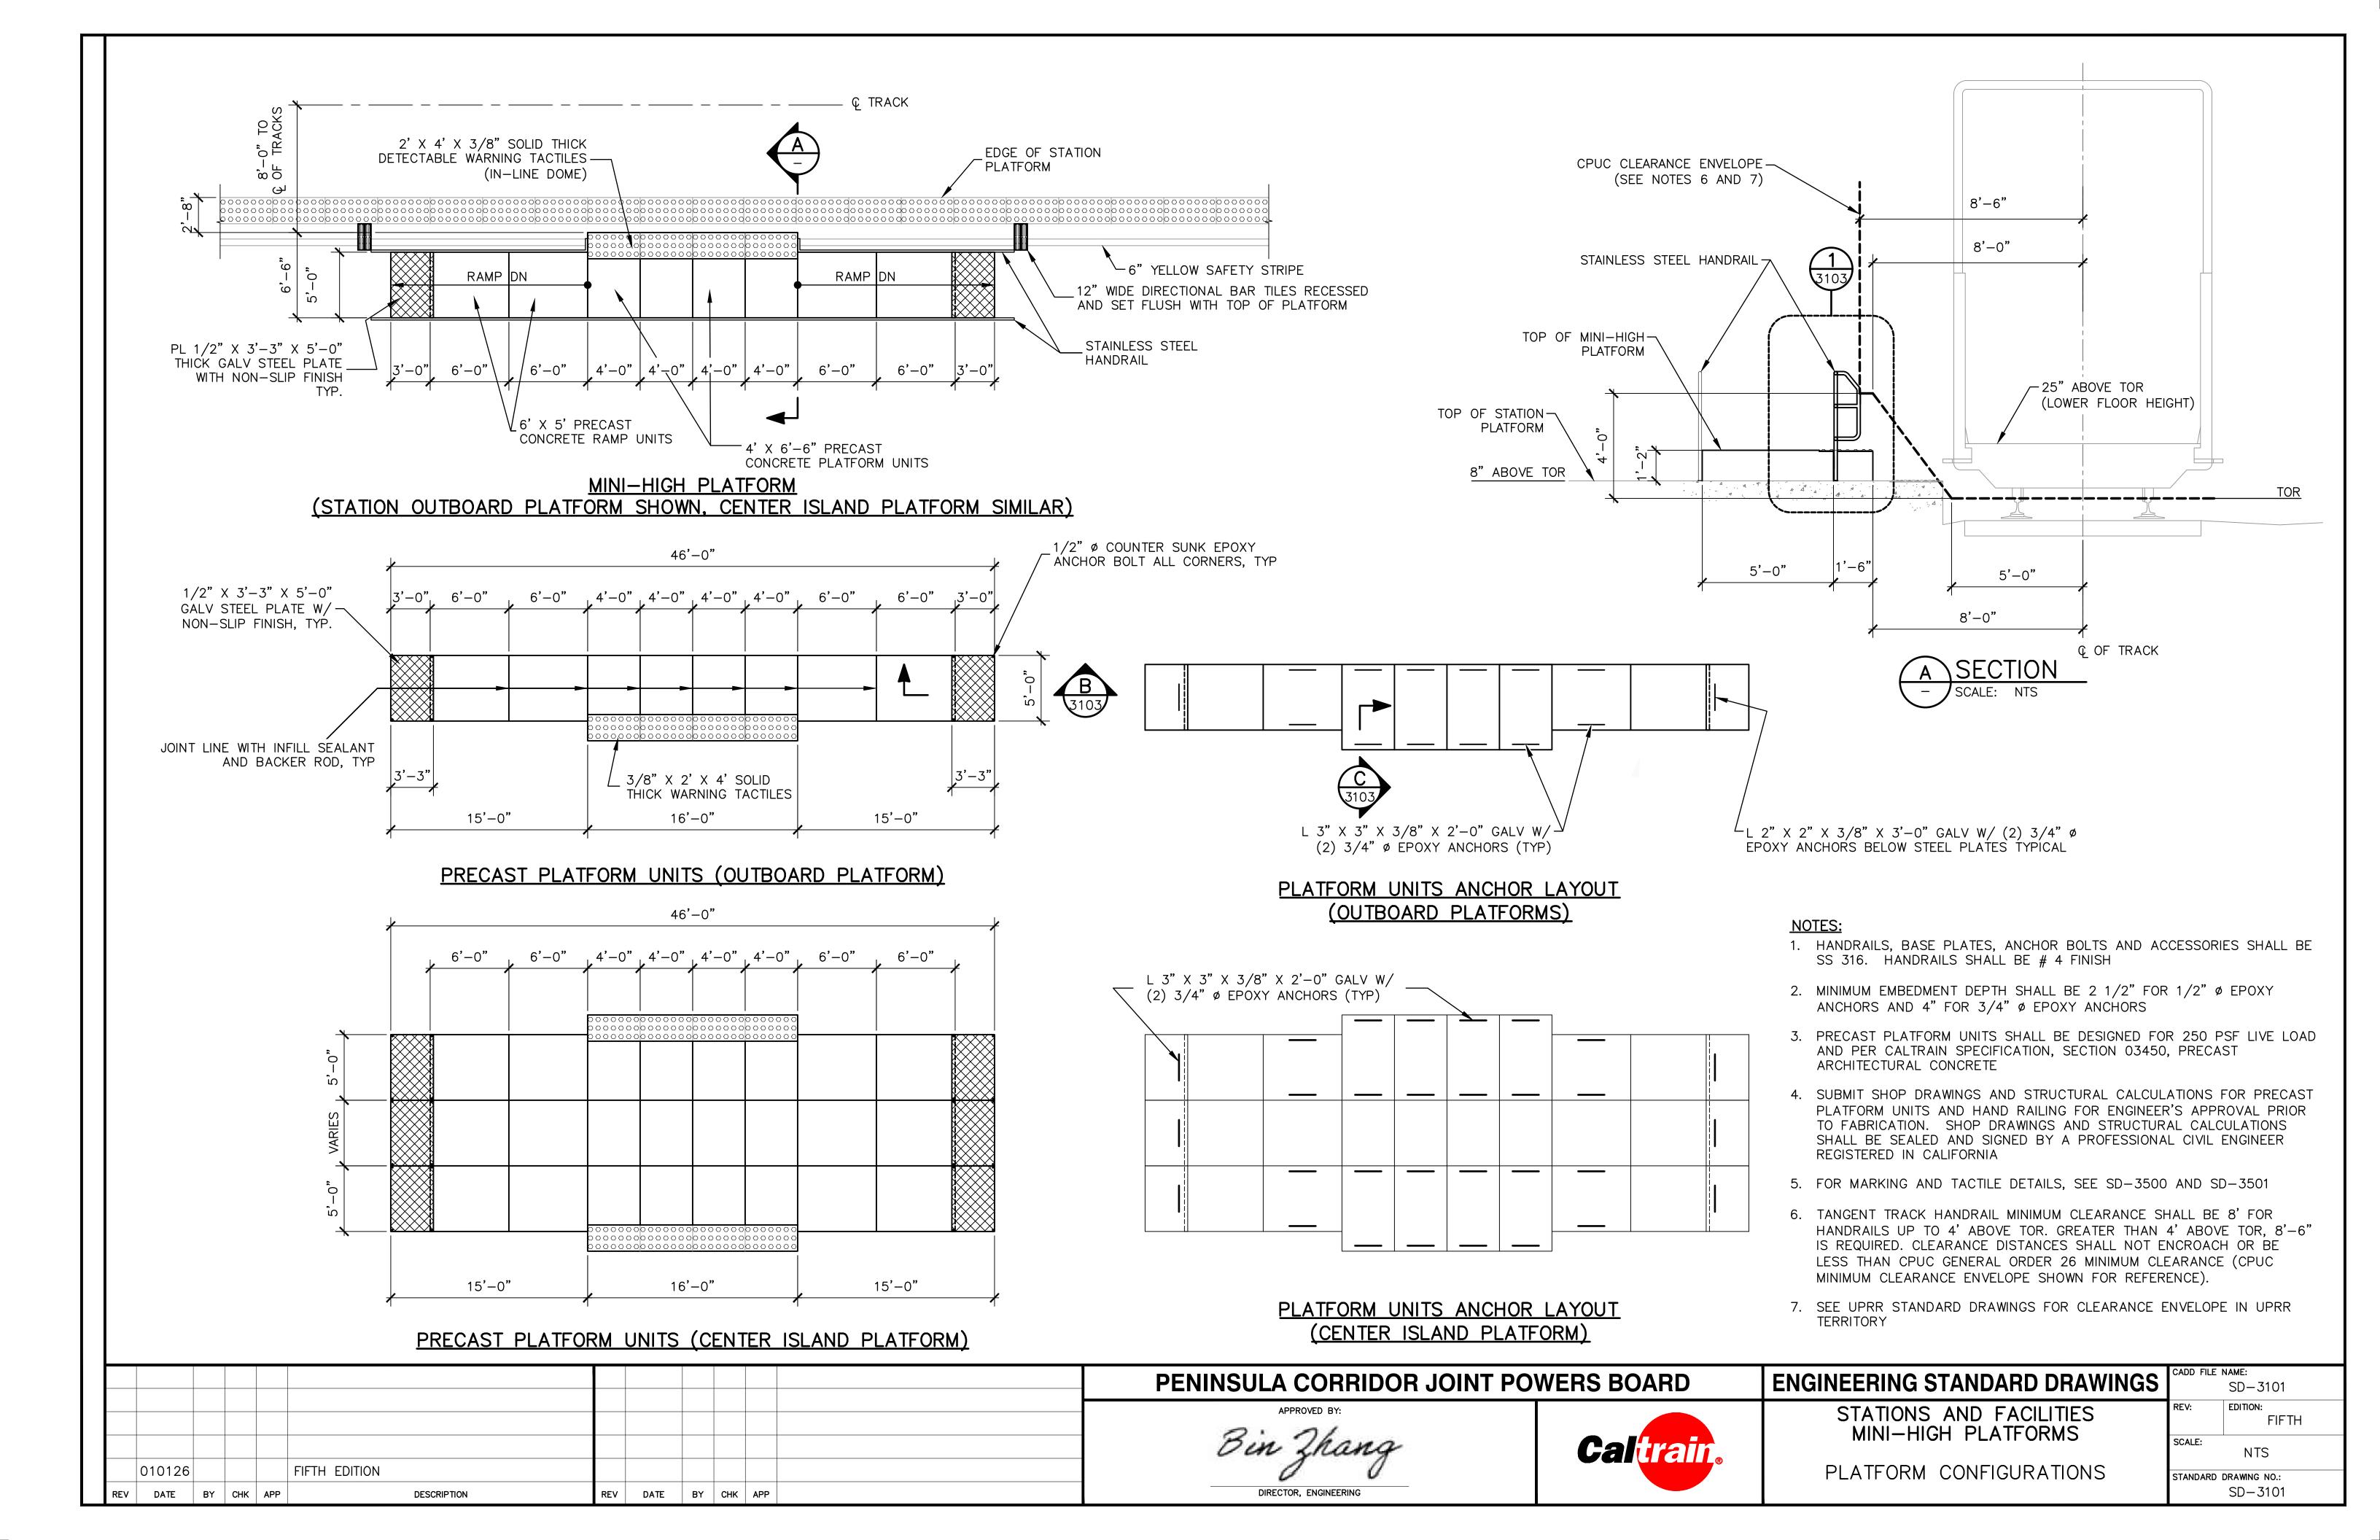

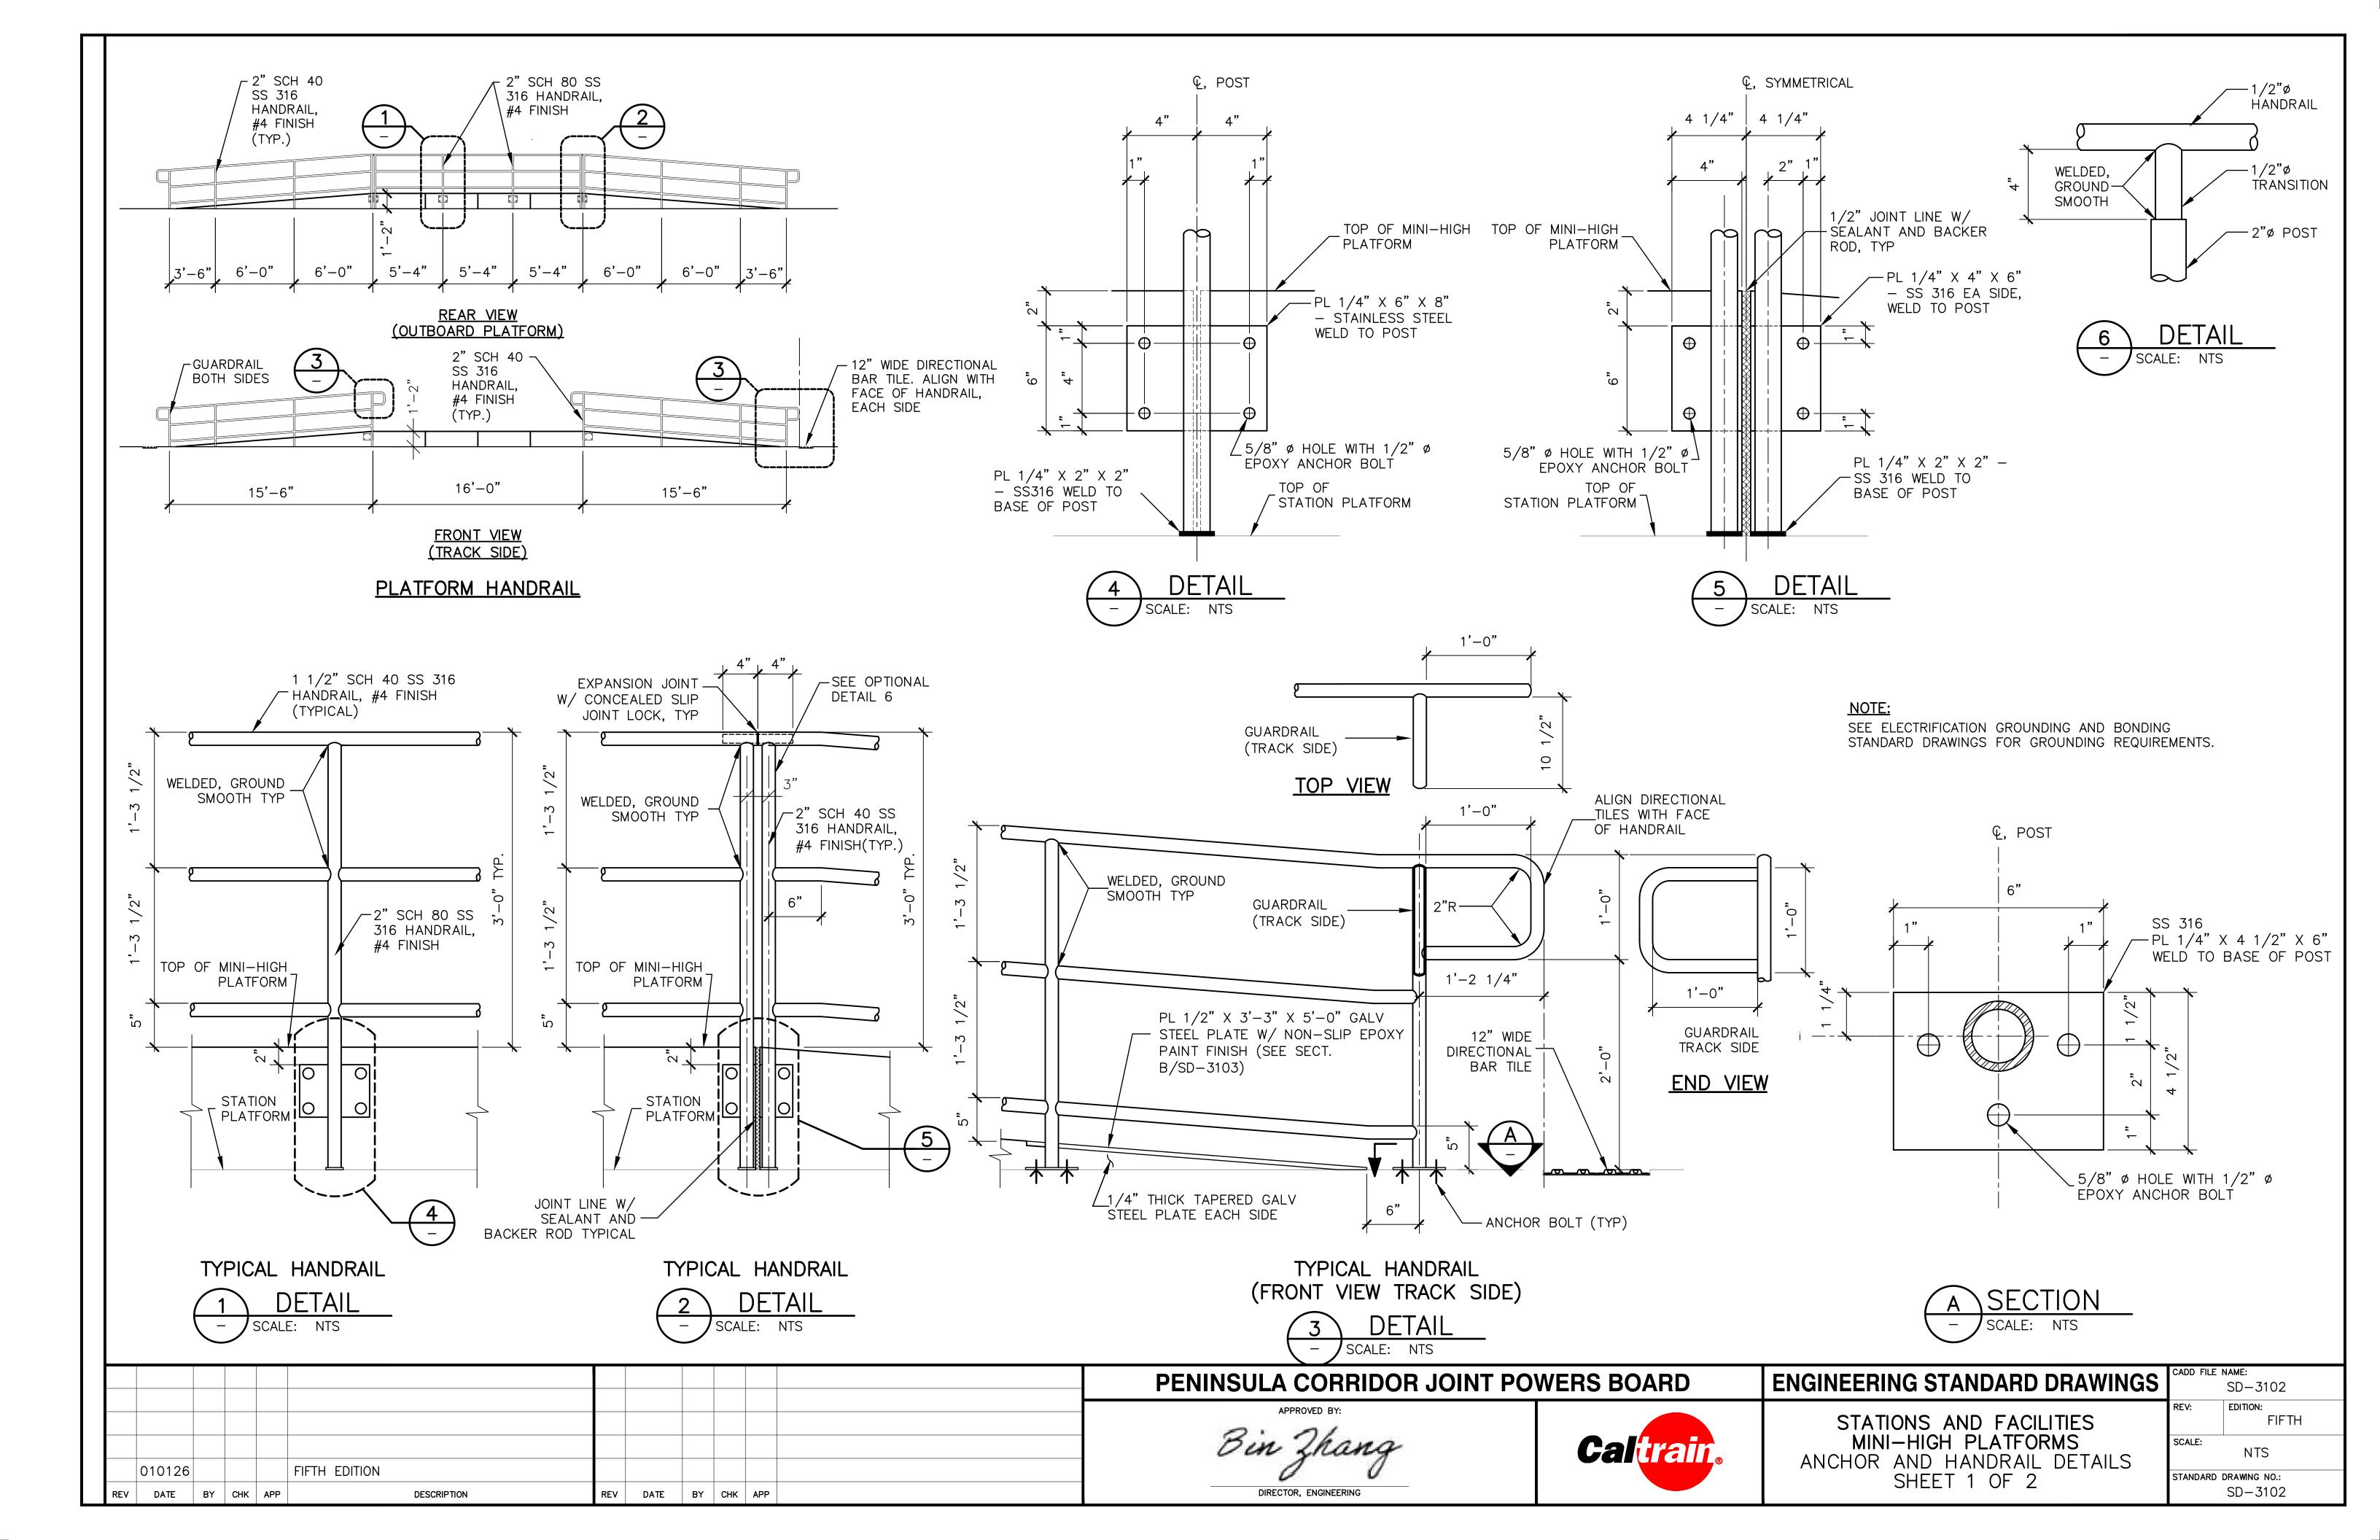

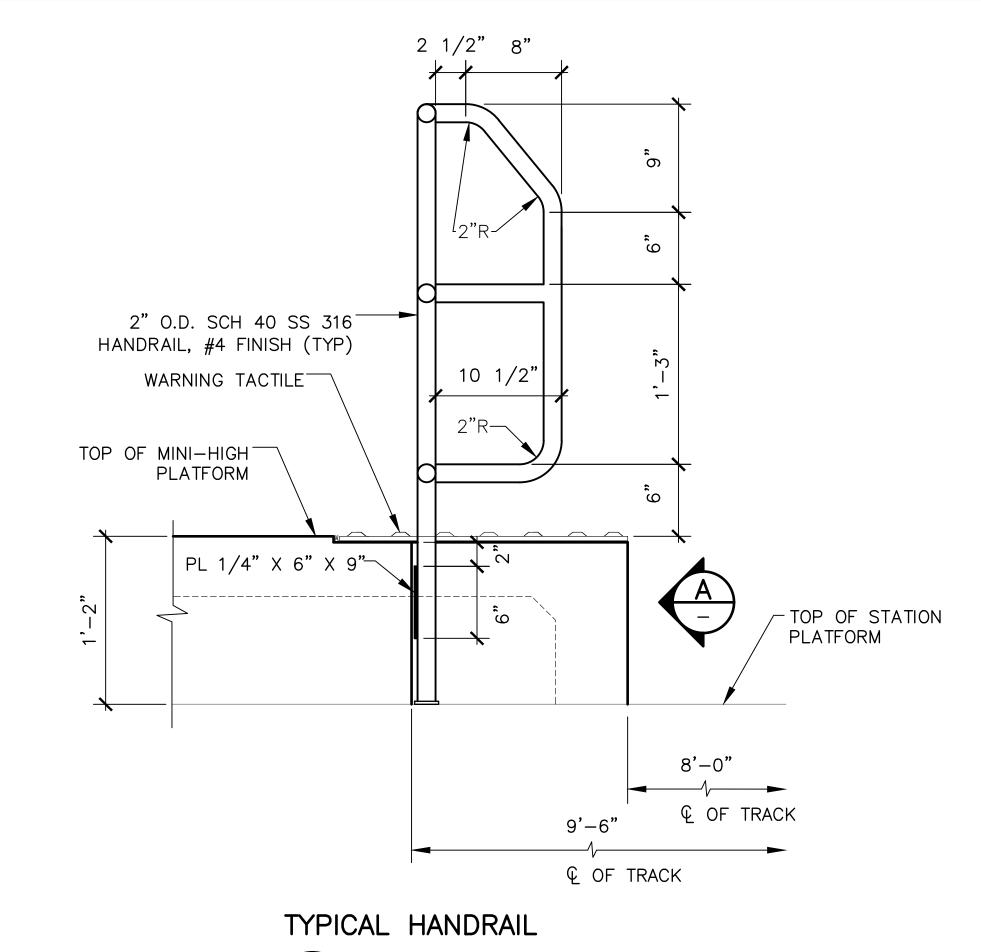





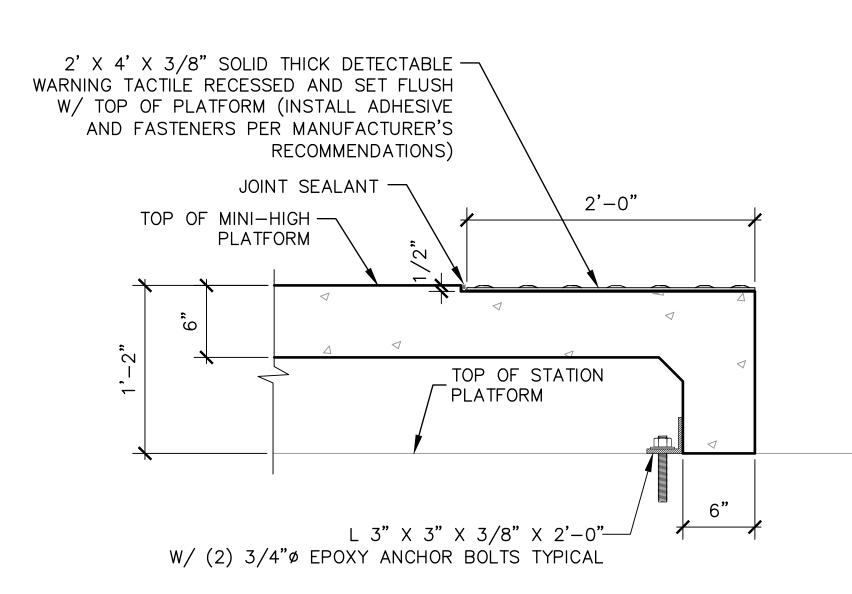

DETECTABLE WARNING TACTILE




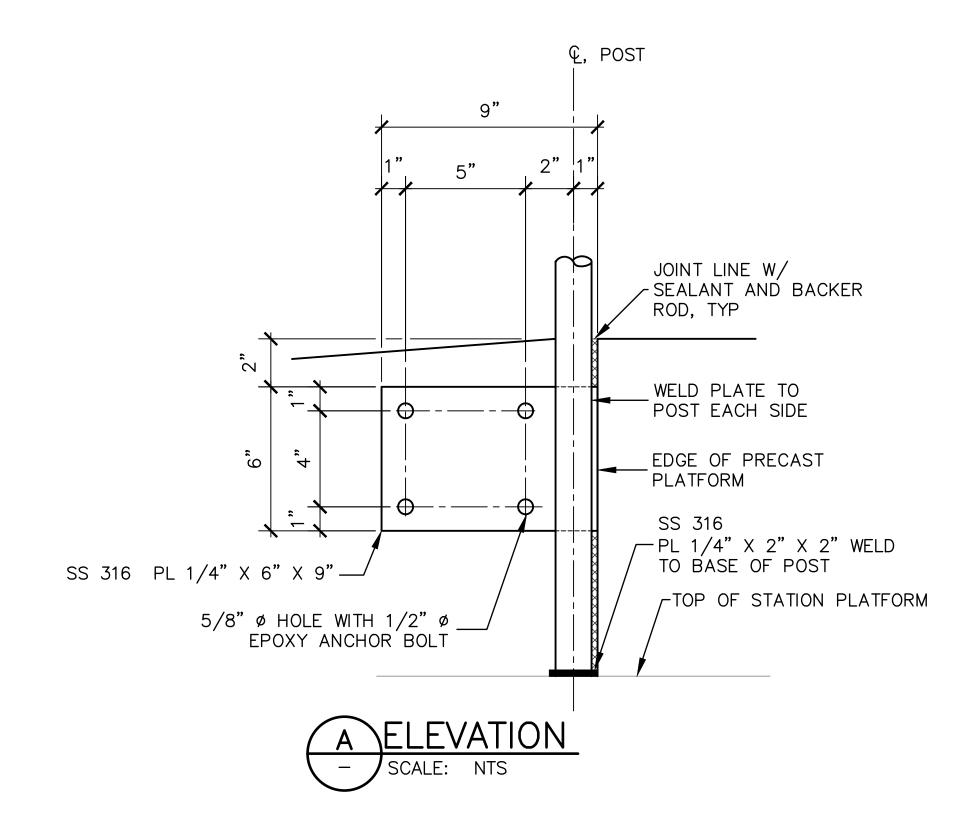

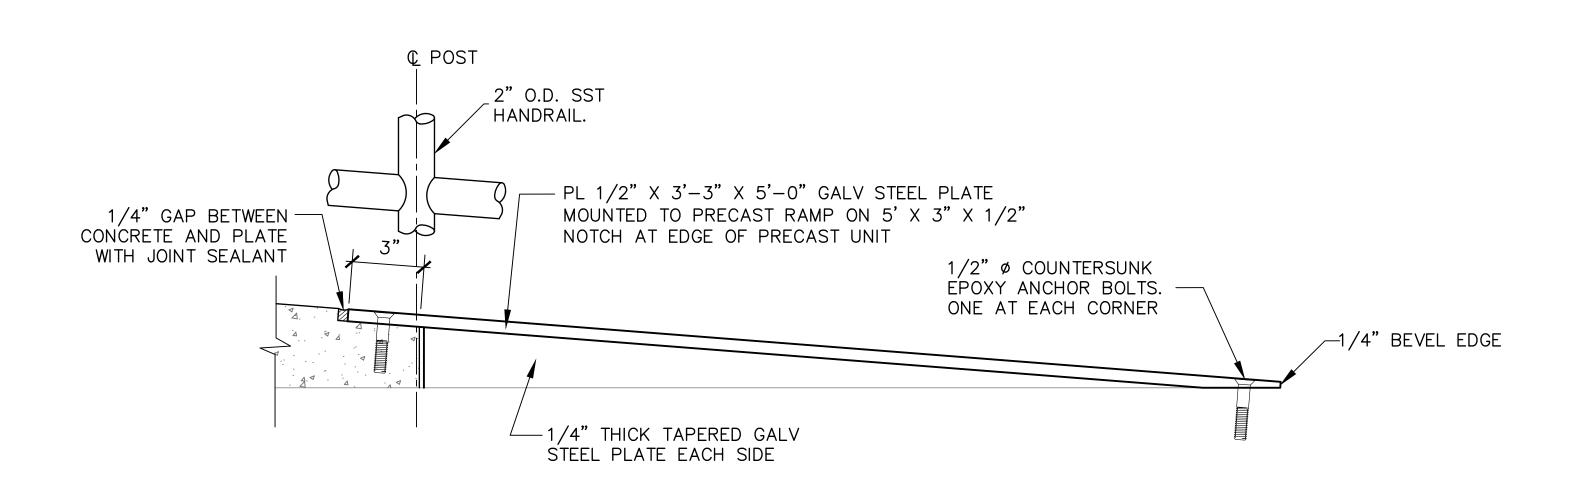

RAMP PLATE DETAILS 3101 B SECTION 3103 SCALE: NTS


	PENINSULA CORRIDOR JOINT POV	WERS BOARD	ENGINEERING STANDARD DRAWINGS	cadd file name: SD-3103
	Bin Zhang	Caltrain	STATIONS AND FACILITIES MINI—HIGH PLATFORMS ANCHOR AND HANDRAIL DETAILS	REV: EDITION: FIFTH SCALE: NTS
O10126 FIFTH EDITION	DIRECTOR, ENGINEERING			STANDARD DRAWING NO.: SD-3103

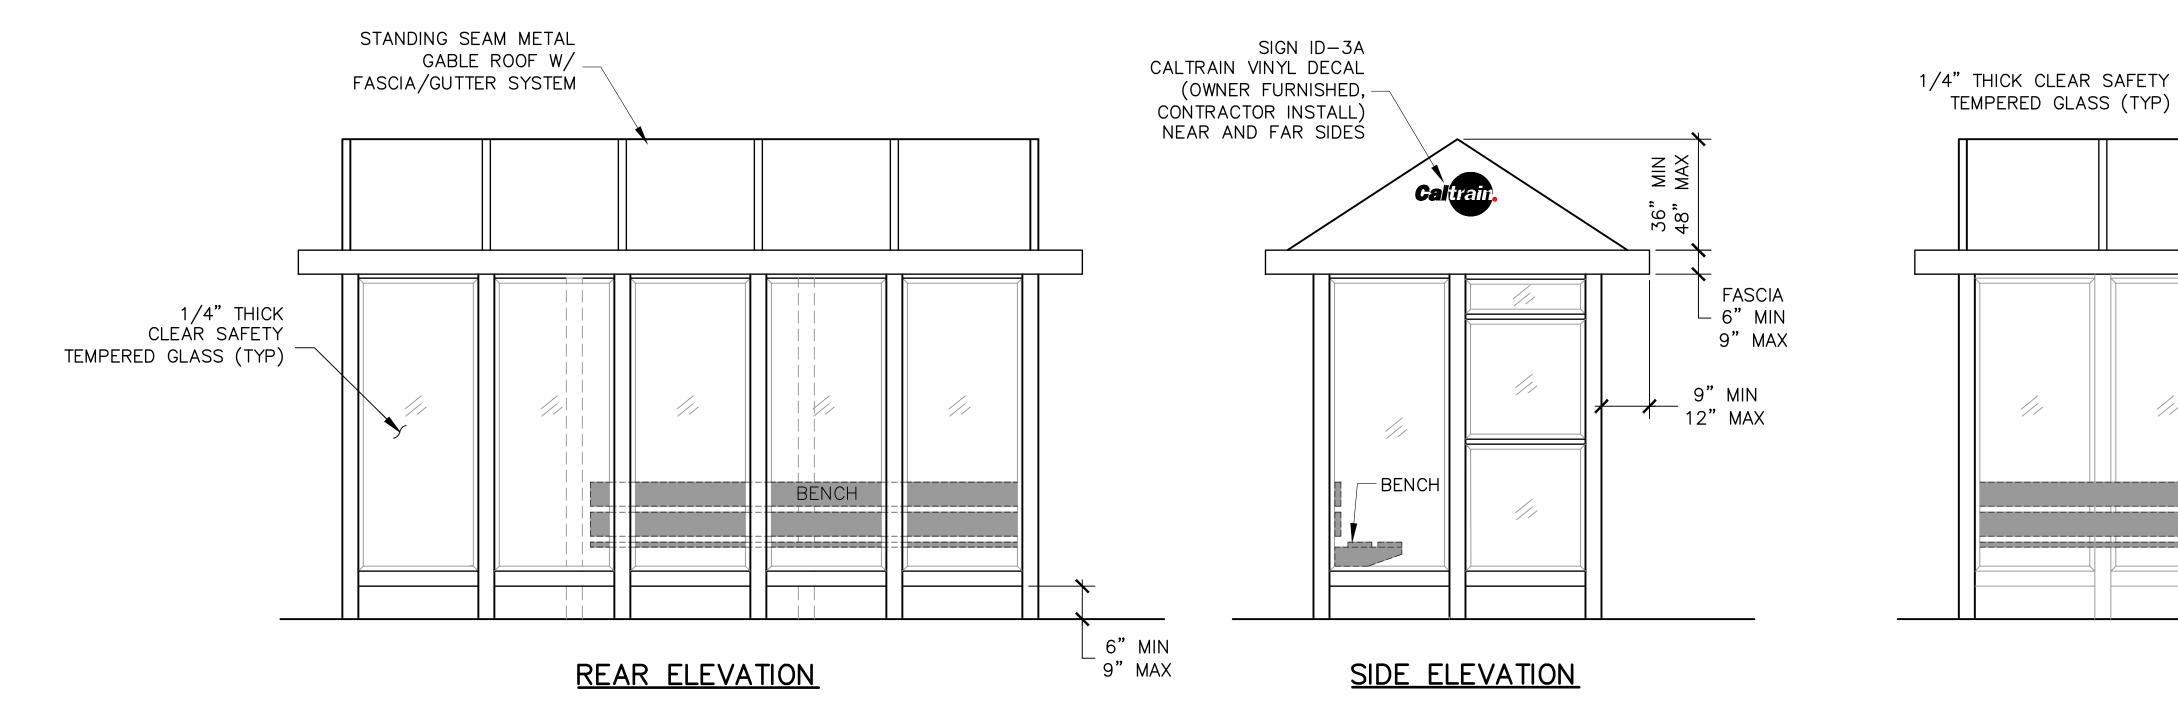

FASCIA 6" MIN 9" MAX -0" MIN CLEAR 8'-0" MAX OTTOM OF FASCIA BENCH

NOTES:

- 1. STRUCTURAL FRAMING MEMBERS AND ROOF SHALL BE DARK BRONZE POWDER COATED ALUMINUM.
- 2. LIGHT SHALL BE WHITE LED.
- 3. BENCHES SHALL BE METALLIC.
- 4. POSTS SHALL BE SECURED IN POST SLEEVES (BOLTED ON PLATFORMS). SLEEVES SHALL BE SAME COLOR AS POSTS. GALVANIZED BOLTS, NUTS AND WASHERS.
- 5. FOR SIGNS, SEE SD-3300.
- 6. SEE ELECTRIFICATION GROUNDING AND BONDING STANDARD DRAWINGS FOR GROUNDING REQUIREMENTS.

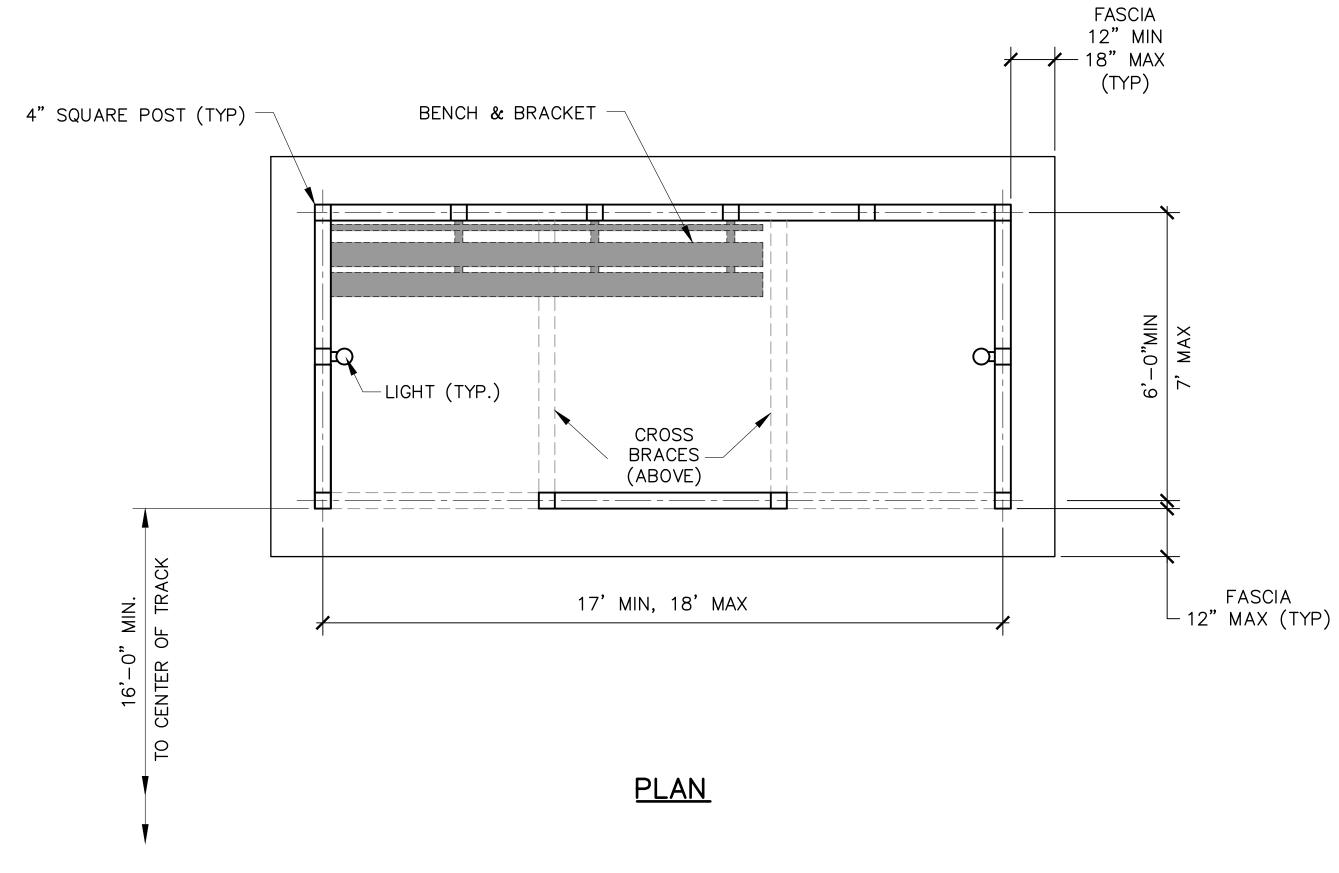


FRONT ELEVATION


								PENINSULA CORR	IDOR JOINT POWERS BOARI
	010126		FIFTH EDITION					Bin Zha	
EV	DATE	BY CHK	APP DESCRIPTION	REV	DATE	BY	CHK APF	DIRECTOR, ENGINEERING	




ENGINEERING STANDARD DRAWINGS	CADD FILE	NAME: SD-3201
STATIONS AND FACILITIES	REV:	EDITION: FIFTH
SHELTERS AND AMENITIES TYPICAL PASSENGER SHELTER	SCALE:	NTS
ON OUTBOARD PLATFORM	STANDARD	drawing no.: SD-3201

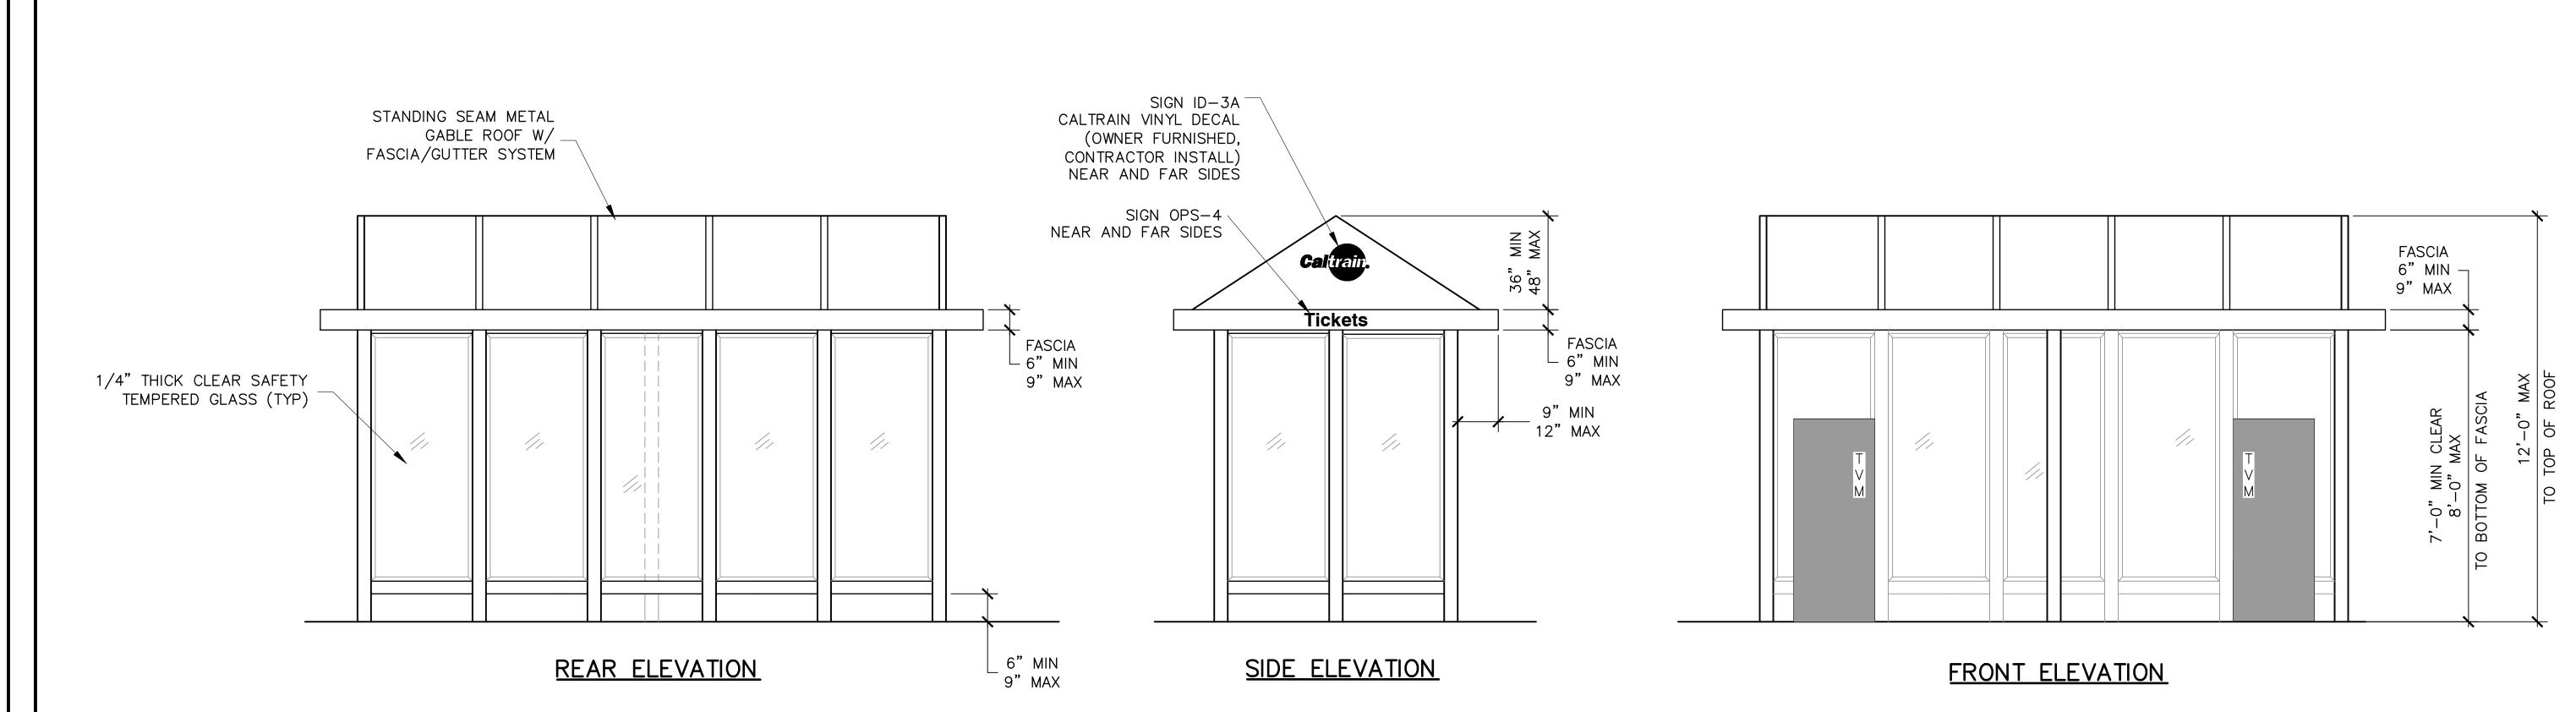


- 1. STRUCTURAL FRAMING MEMBERS AND ROOF SHALL BE DARK BRONZE POWDER COATED ALUMINUM.
- 2. LIGHT SHALL BE WHITE LED.
- POSTS SHALL BE SECURED IN POST SLEEVES (BOLTED ON PLATFORMS). SLEEVES SHALL BE SAME COLOR AS POSTS. GALVANIZED BOLTS, NUTS AND WASHERS.
- 4. FOR SIGNS, SEE SD-3300.
- 5. THE FOOTPRINT FOR THE TVM UNITS SHALL BE LEVEL AND FLUSH WITH THE PLATFORM FLOOR. NO PEDESTAL IS REQUIRED.
- 6. SEE ELECTRIFICATION GROUNDING AND BONDING STANDARD DRAWINGS FOR GROUNDING REQUIREMENTS.

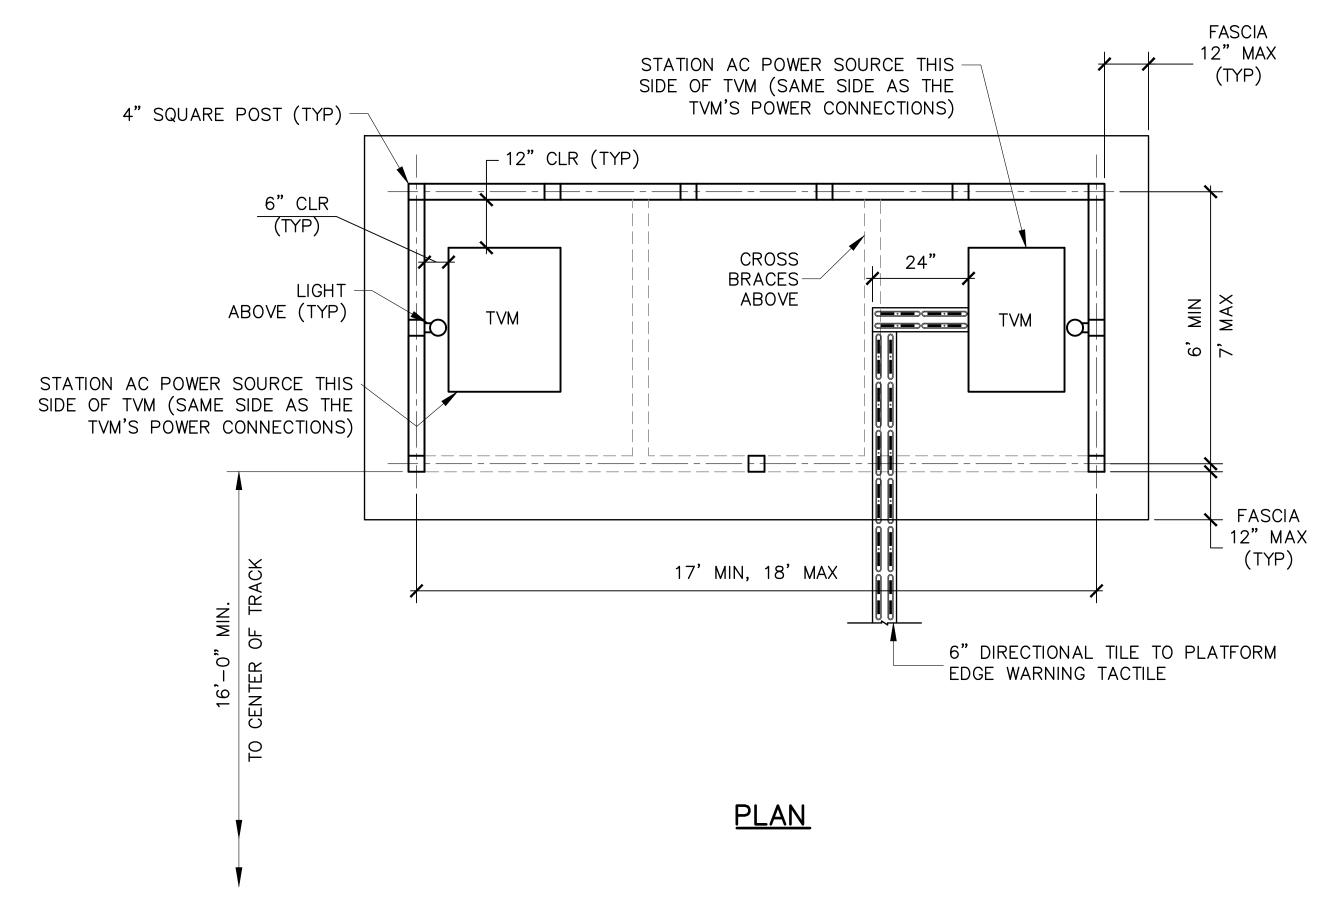


						PENINSULA CORRIDOR JOINT PO	WERS BOARD	ENGINEERING STANDARD DRAWINGS	
						Bin Zhang	Caltrain	STATIONS AND FACILITIES SHELTERS AND AMENITIES TYPICAL TVM SHELTER	REV: EDITION: FIFTH SCALE: NTS
010126 REV DATE	BY CHK APP	DESCRIPTION	REV DATE	BY CHK	APP	DIRECTOR, ENGINEERING		ON OUTBOARD PLATFORM	STANDARD DRAWING NO.: SD-3202

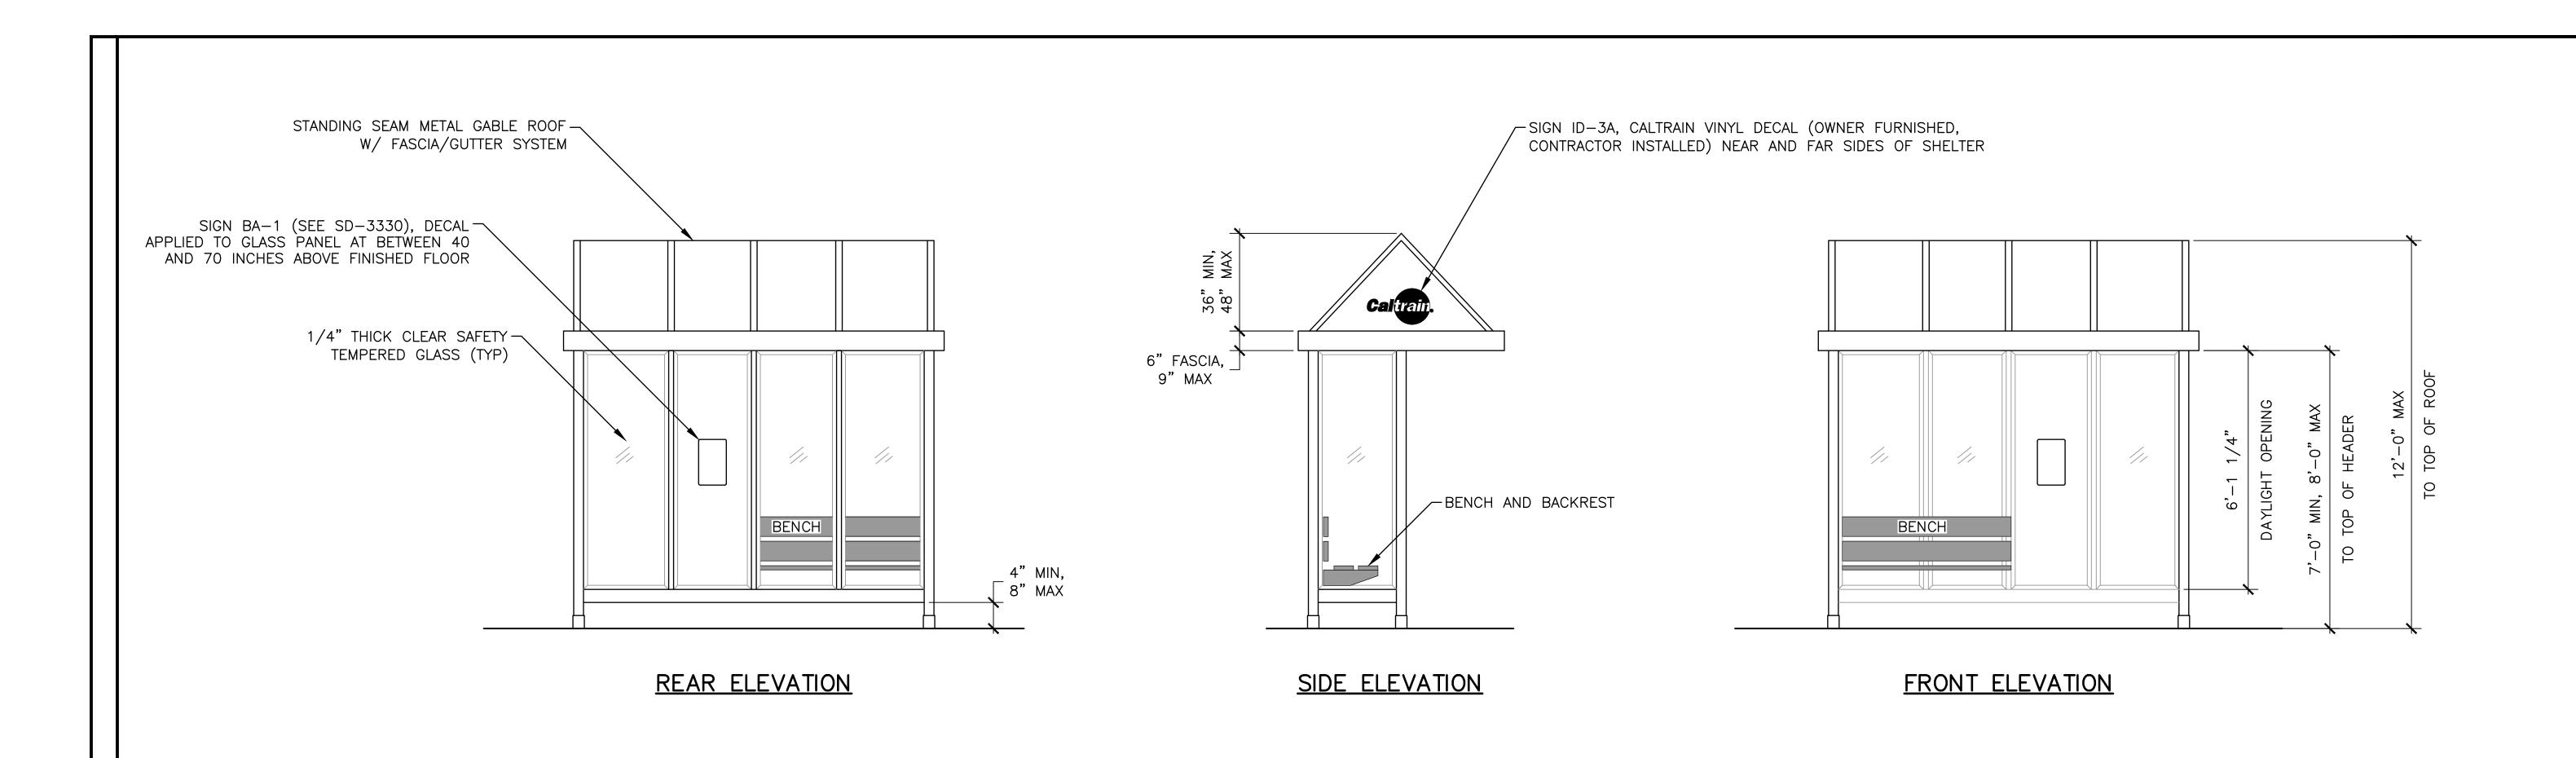


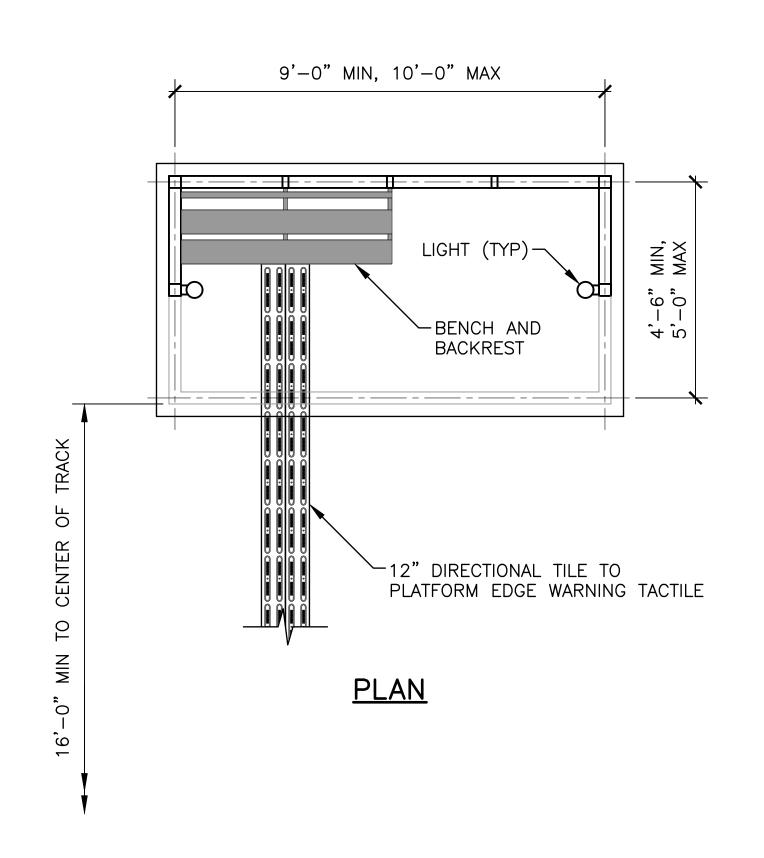

- 1. SEE SD-3305 FOR BOARDING ASSISTANCE AREA SIGNS. EXCEPT SINGLE SIDED ONLY.
- 2. LIGHT SHALL BE WHITE LED.
- 3. STRUCTURAL FRAMING MEMBERS AND ROOF SHALL BE DARK BRONZE POWDER COATED ALUMINUM.
- 4. POSTS SHALL BE SECURED IN POST SLEEVES (BOLTED ON TO PLATFORM).
 SLEEVES SHALL BE SAME COLOR AS POSTS. BOLTS, NUTS AND WASHERS SHALL
 BE GALVANIZED.
- 5. BENCHES SHALL BE METALLIC.
- 6. FOR SIGNAGE, SEE SD-3300.
- 7. SEE ELECTRIFICATION GROUNDING AND BONDING STANDARD DRAWINGS FOR GROUNDING REQUIREMENTS.

							PENINSULA CORRIDOR JOINT PO	WERS BOARD	ENGINEERING STANDARD DRAWINGS	cadd file name: SD-3203
							Bin Zhang	Calivair	STATIONS AND FACILITIES SHELTERS AND AMENITIES	REV: EDITION: FIFTH SCALE:
REV	01012 v DATE	FIFTH EDITION	DESCRIPTION	RFV DATE	BY CH	APP	DIRECTOR, ENGINEERING	Galla	TYPICAL PNA SHELTER	STANDARD DRAWING NO.: SD-3203

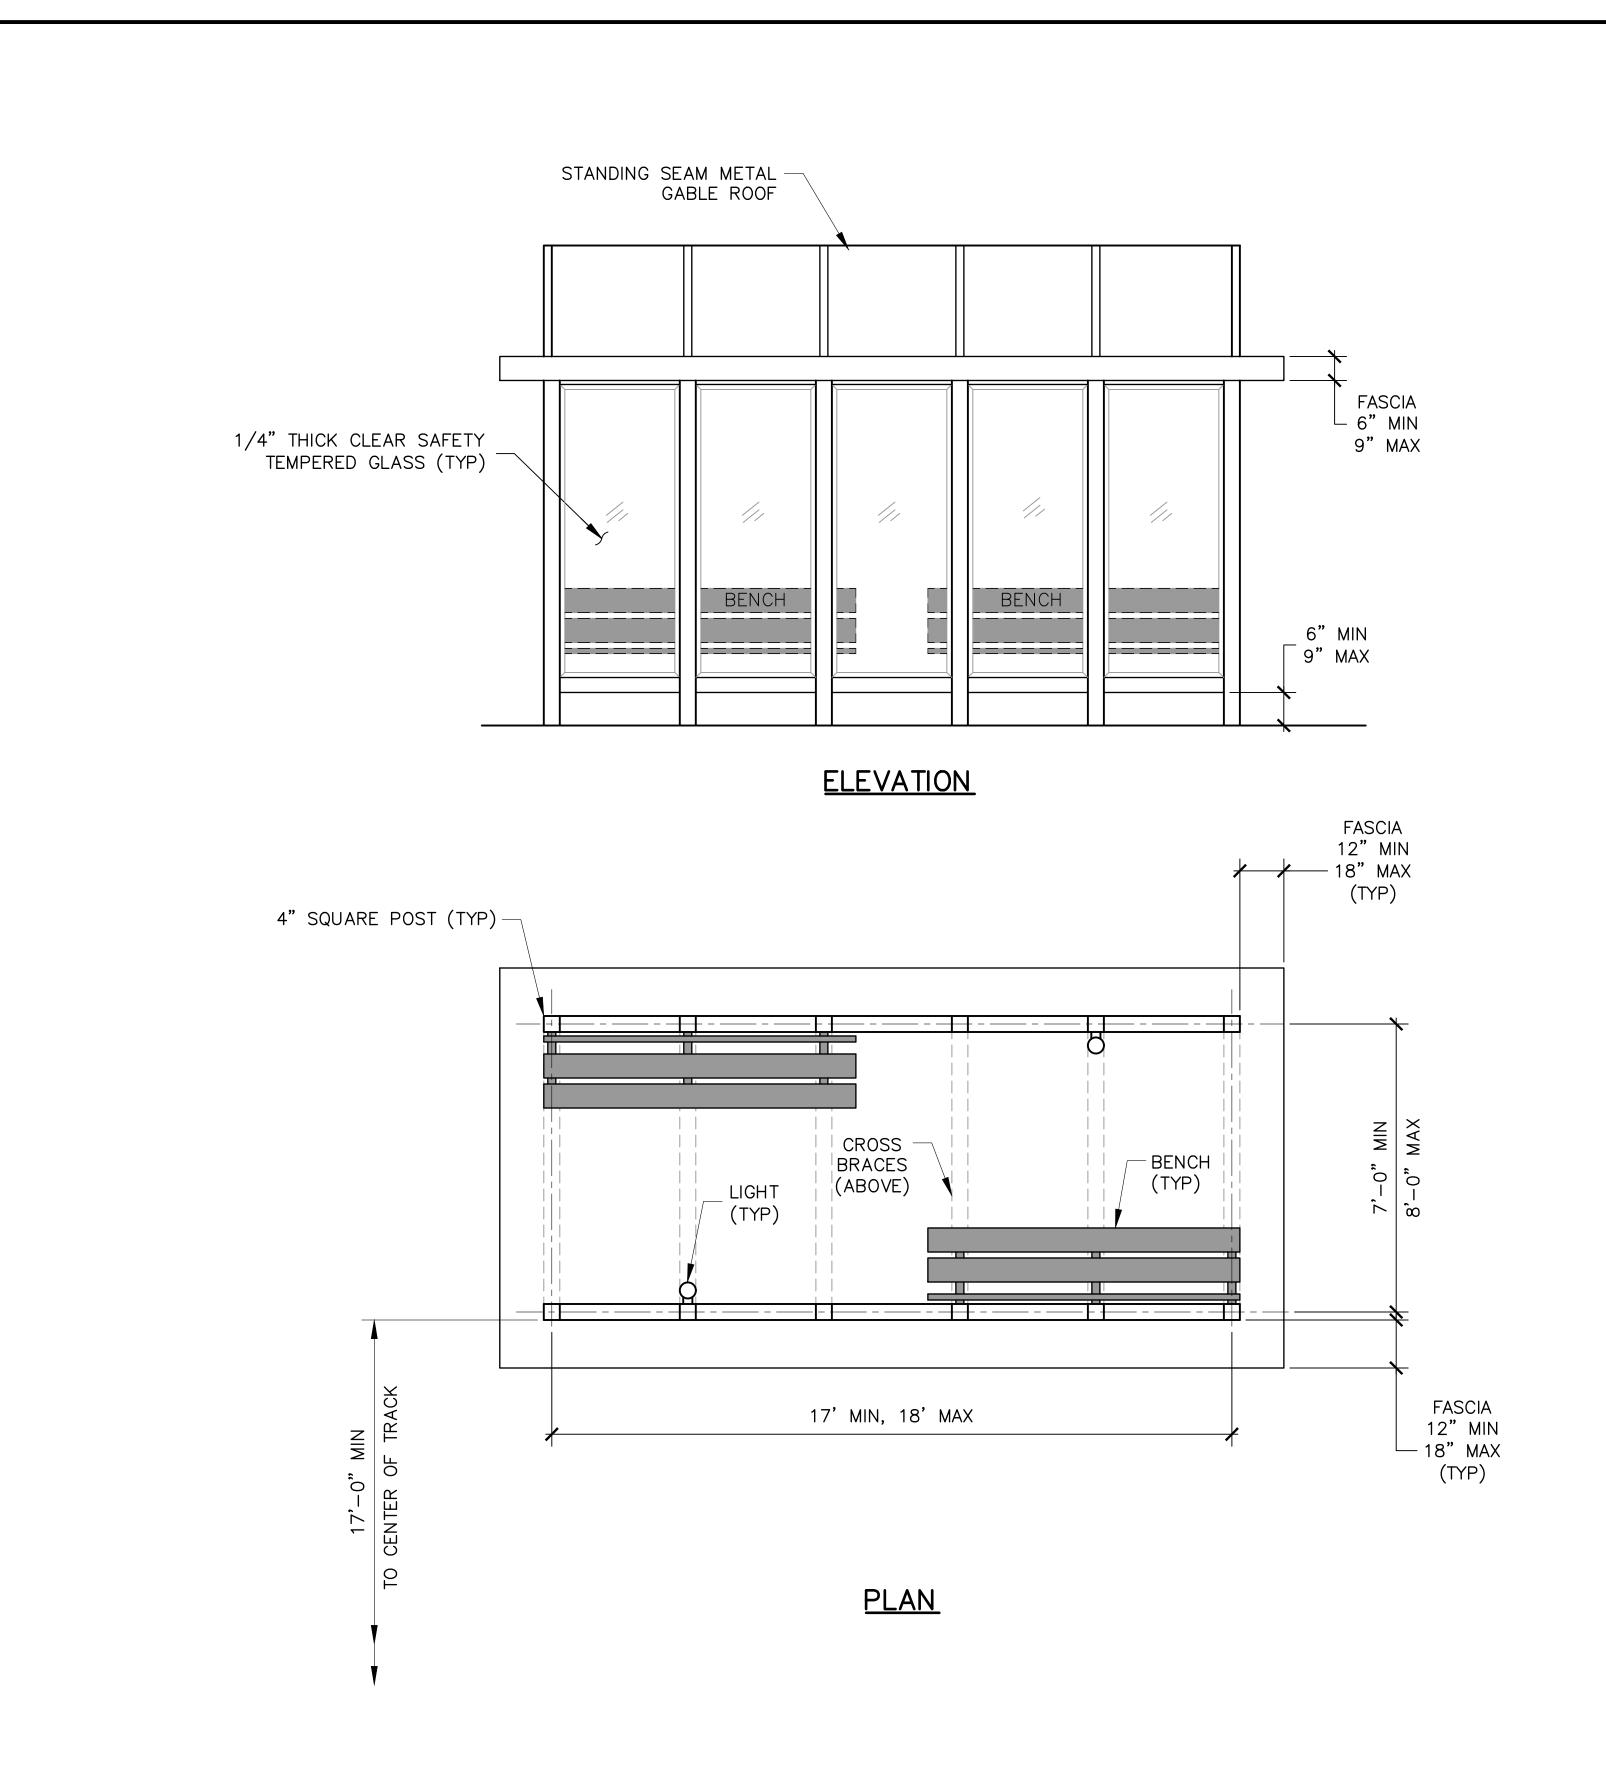


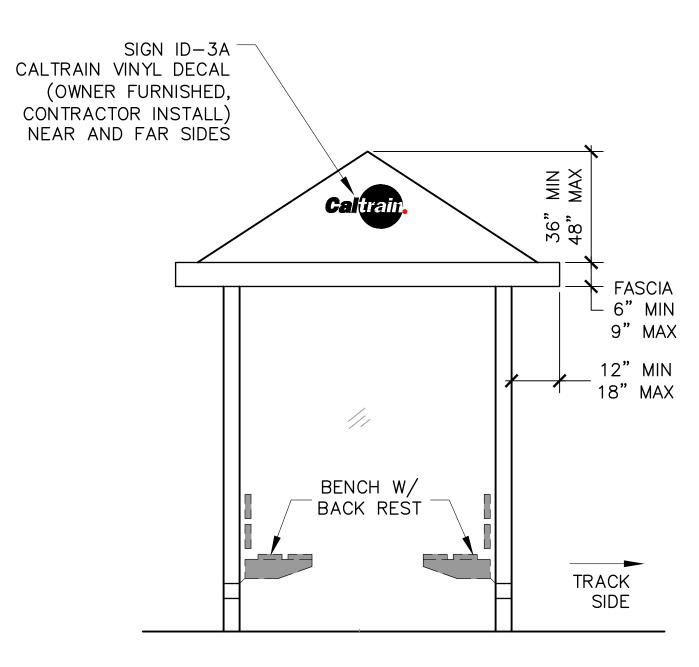


SIDE ELEVATION

- 1. STRUCTURAL FRAMING MEMBERS AND ROOF SHALL BE DARK BRONZE POWDER COATED ALUMINUM.
- 2. LIGHT SHALL BE WHITE LED.
- 3. POSTS SHALL BE SECURED IN POST SLEEVES (BOLTED ON PLATFORMS). SLEEVES SHALL BE SAME COLOR AS POSTS. GALVANIZED BOLTS, NUTS AND WASHER.
- 4. BENCHES SHALL BE METALLIC.
- 5. FOR SIGNS, SEE SD-3300.
- 6. SEE ELECTRIFICATION GROUNDING AND BONDING STANDARD DRAWINGS FOR GROUNDING REQUIREMENTS.

				PENINSULA CORRIDOR JOINT PO	WERS BOARD	ENGINEERING STANDARD DRAWINGS	CADD FILE	NAME: SD-3204
				Bin Zhang	Caltrain	STATIONS AND FACILITIES SHELTERS AND AMENITIES TYPICAL PASSENGER SHELTER	REV:	EDITION: FIFTH NTS
RE	FIFTH EDITION DESCRIPTION	REV DATE BY	CHK APP	DIRECTOR, ENGINEERING			STANDARD	DRAWING NO.: SD-3204

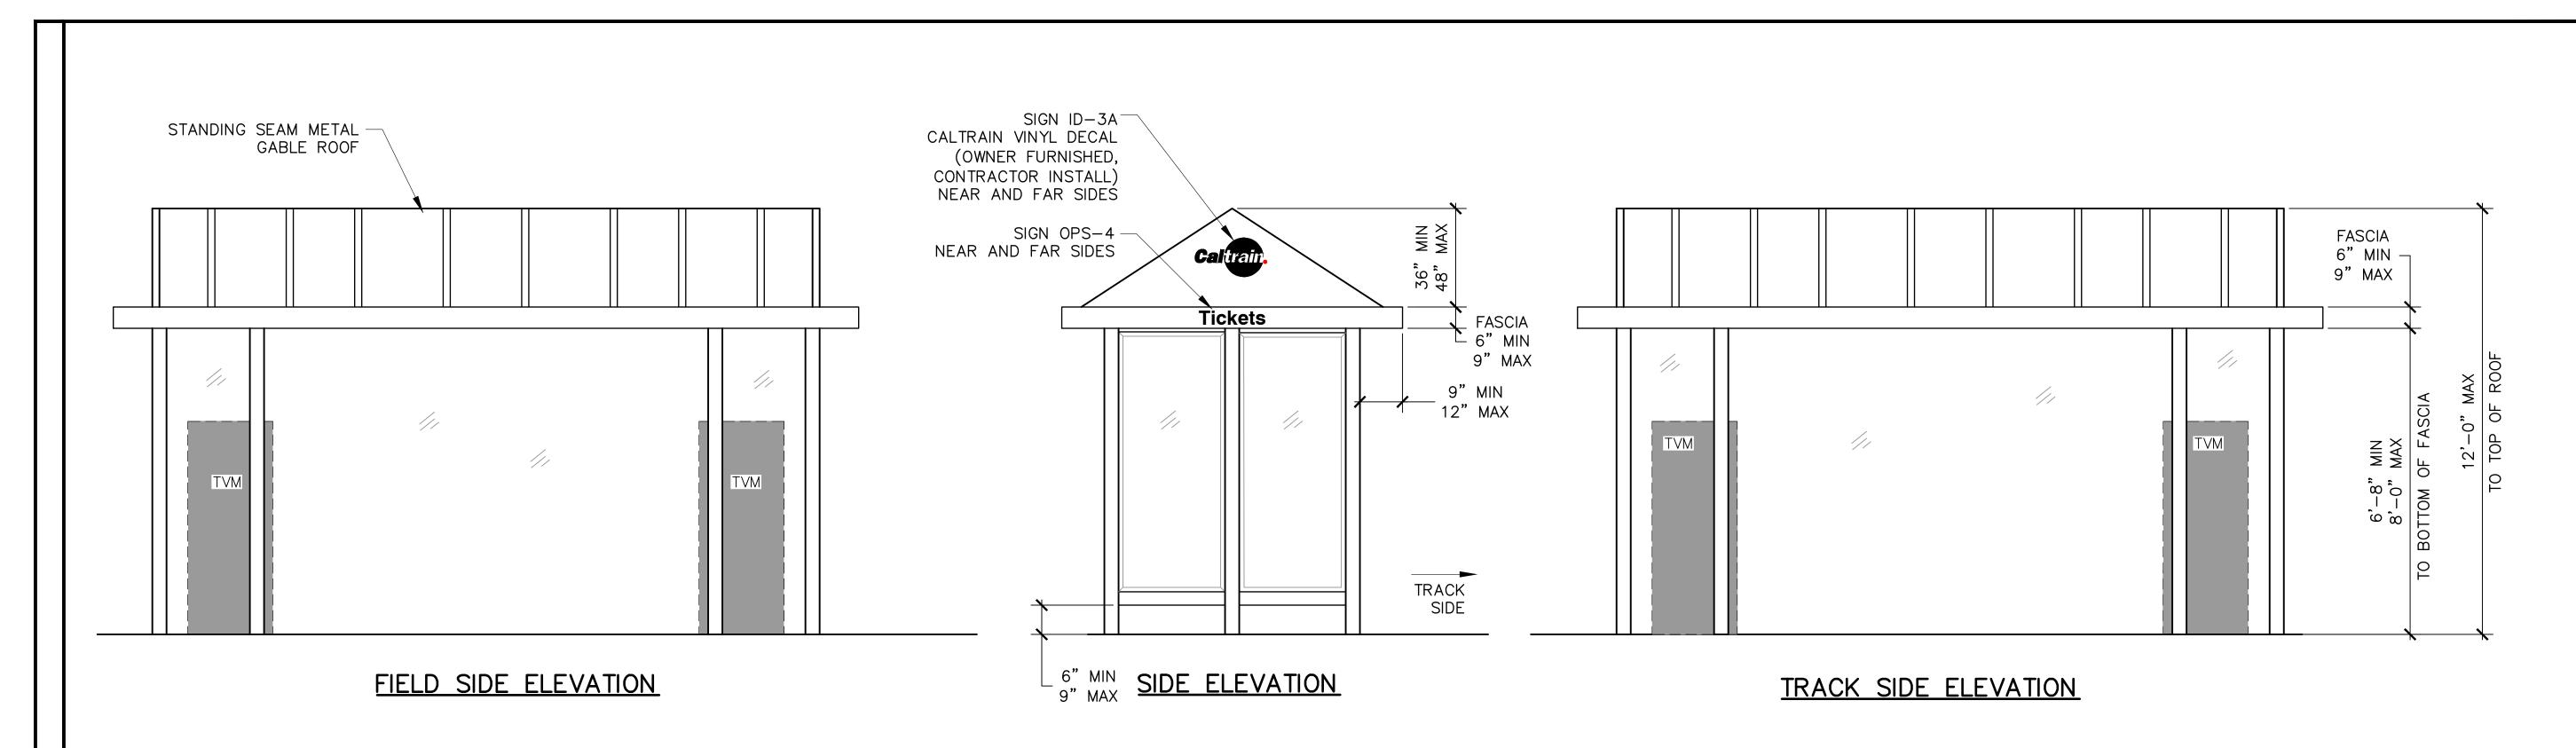

- 1. LIGHT SHALL BE WHITE LED.
- 2. OPERATING CONTROLS FOR TICKET VENDING MACHINES WILL BE PLACED NO HIGHER THAN 54" FROM THE GROUND AND NO LOWER THAN 35".
- 3. STRUCTURAL FRAMING MEMBERS AND ROOF SHALL BE CHOCOLATE BROWN POWDER COATED ALUMINUM.
- 4. POSTS SHALL BE SECURED IN POST SLEEVES (BOLTED ON PLATFORMS).
 SLEEVES SHALL BE SAME COLOR AS POSTS. GALVANIZED BOLTS, NUTS AND WASHERS.
- 5. FOR SIGNS, SEE SD-3300.
- 6. THE FOOTPRINT FOR THE UNITS SHALL BE LEVEL AND FLUSH WITH THE PLATFORM FLOOR. NO PEDESTAL IS REQUIRED.
- 7. SEE ELECTRIFICATION GROUNDING AND BONDING STANDARD DRAWINGS FOR GROUNDING REQUIREMENTS.

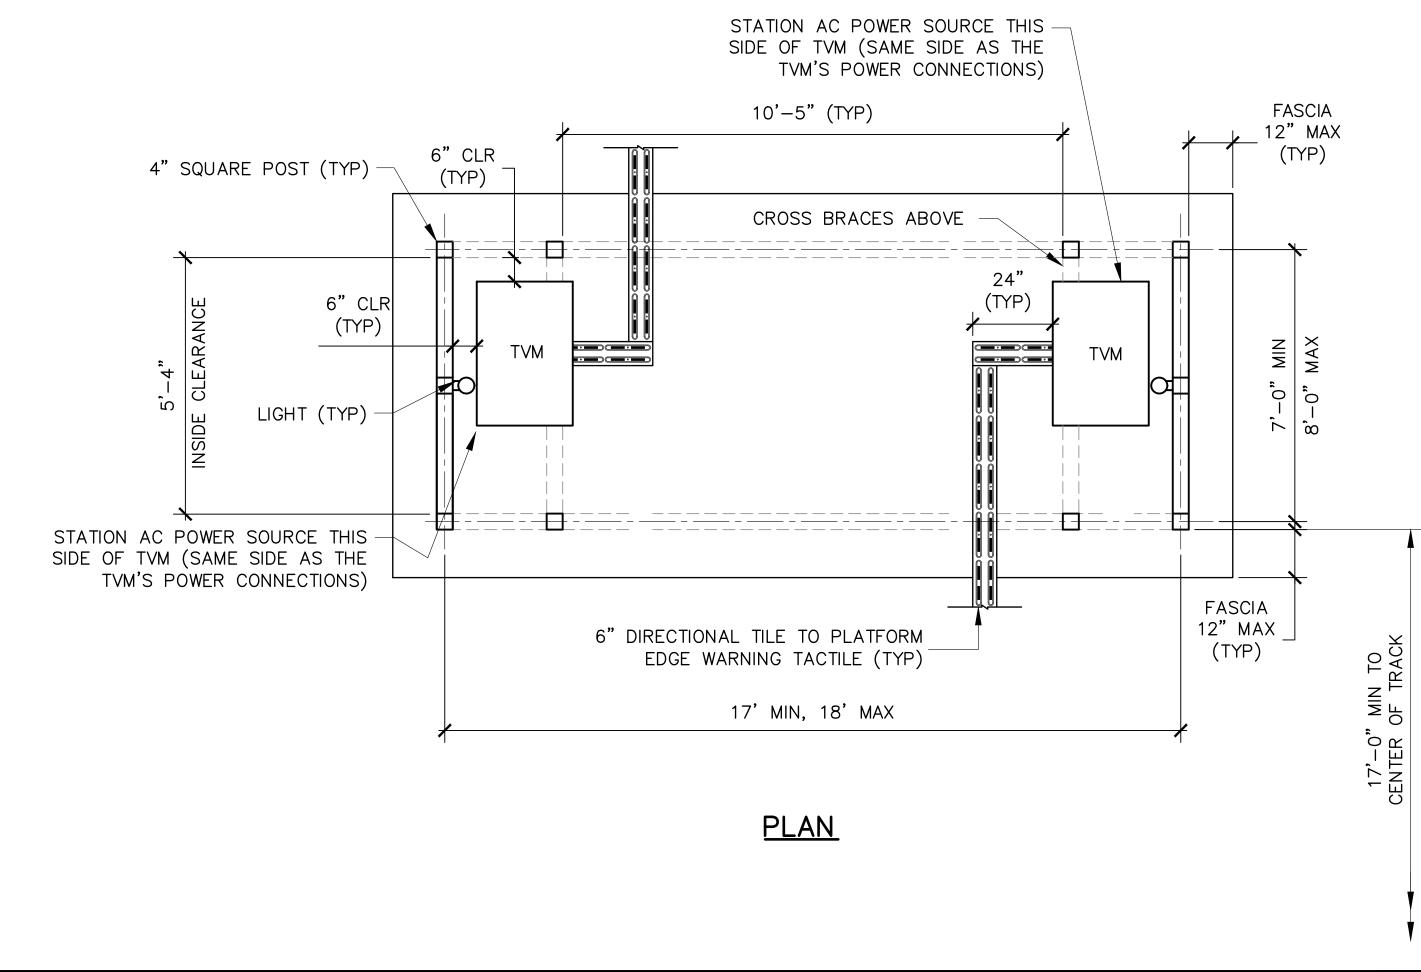


RE	V DA	TE	BY	CHK APP	DESCRIPTION	REV	DATE	BY	CHK	APP	
	010	126			FIFTH EDITION						


DIRECTOR, ENGINEERING


PENINSULA CORRIDOR JOINT POWERS BOARD



ENGINEERING STANDARD DRAWINGS	CADD FILE	NAME: SD-3205
STATIONS AND FACILITIES	REV:	EDITION: FIFTH
SHELTERS AND AMENITIES TYPICAL TVM SHELTER	SCALE:	NTS
ON CENTER ISLAND PLATFORM	STANDARD	drawing no.: SD-3205

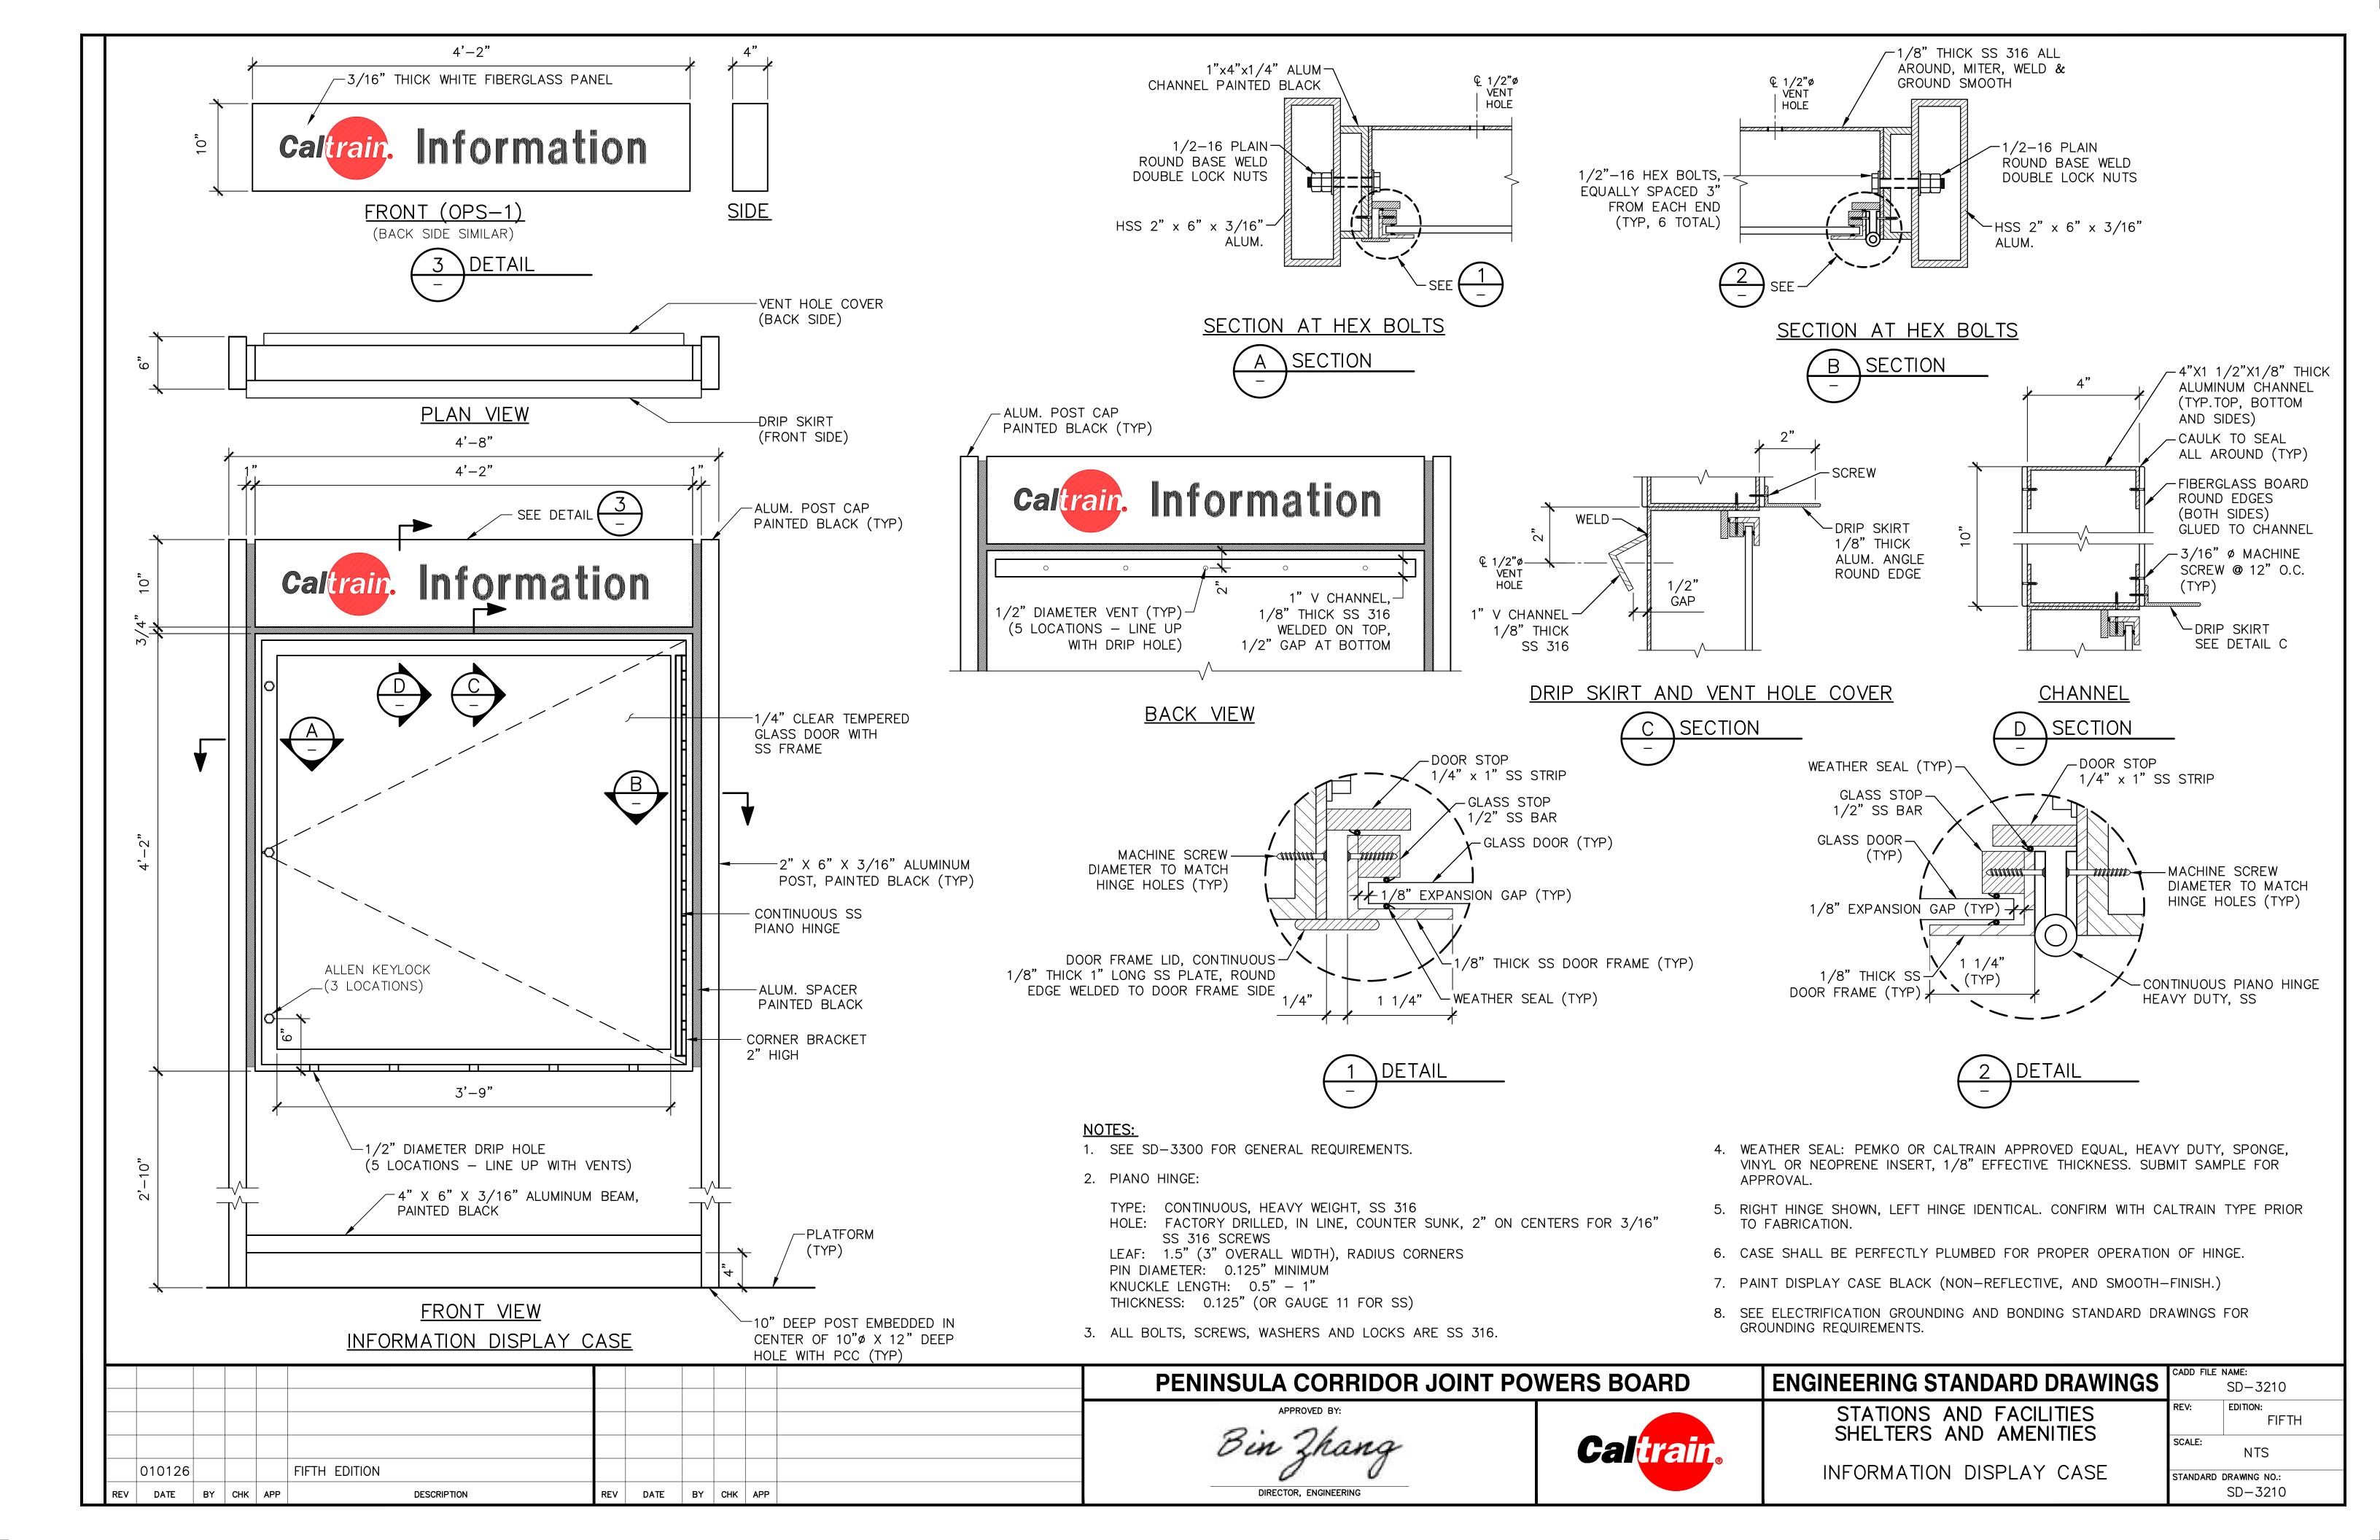

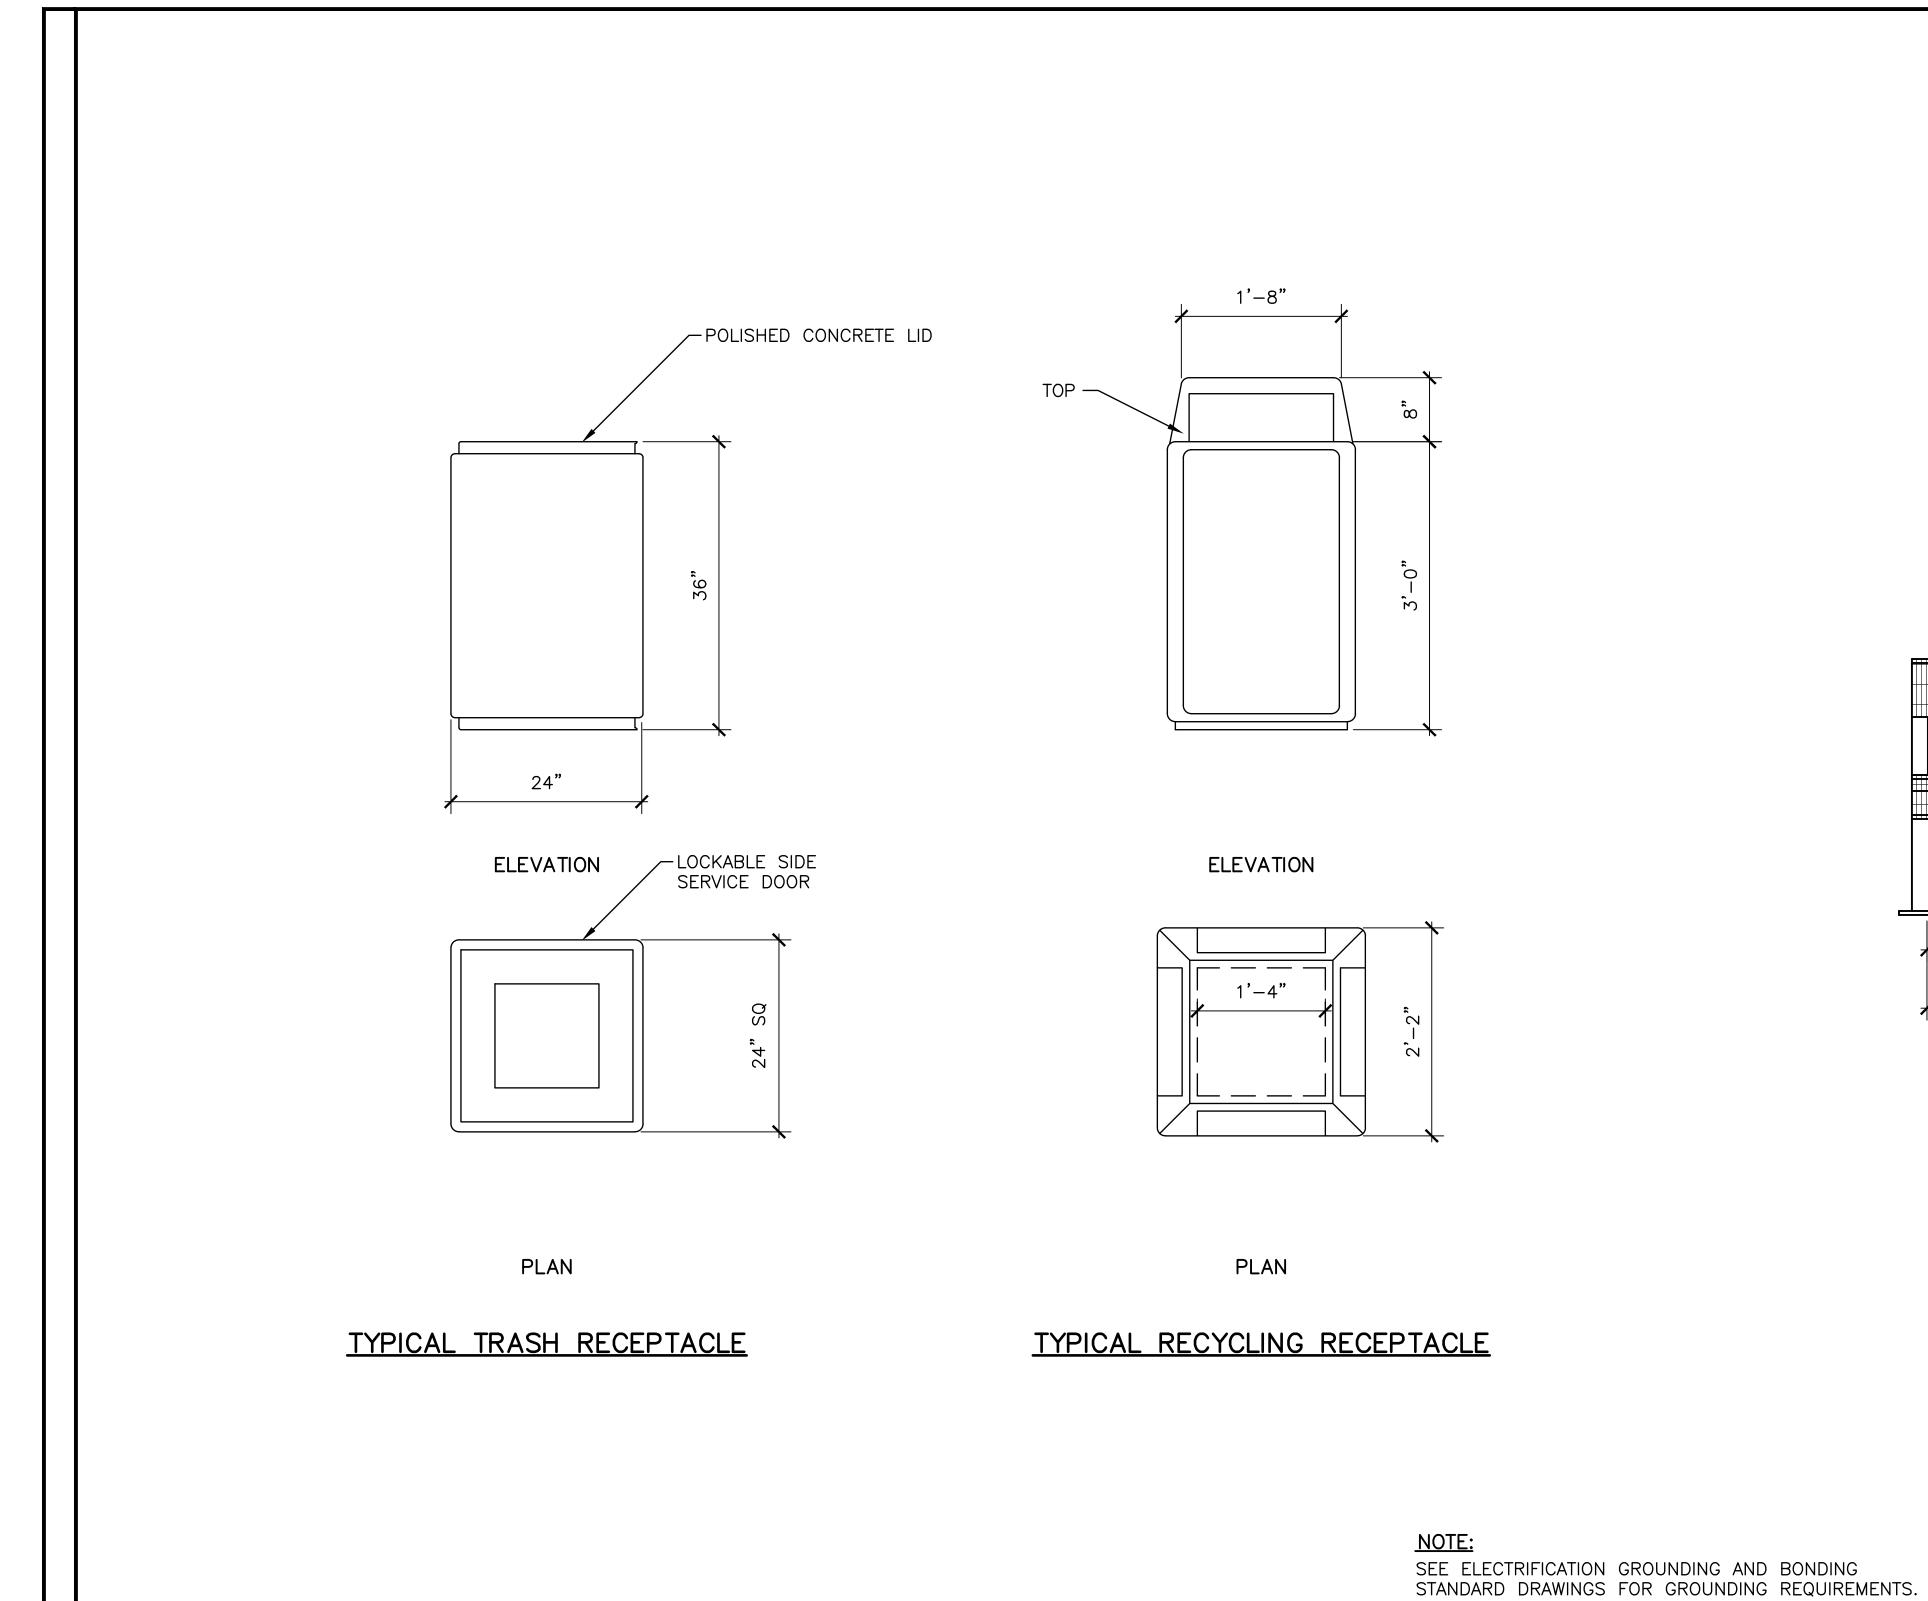

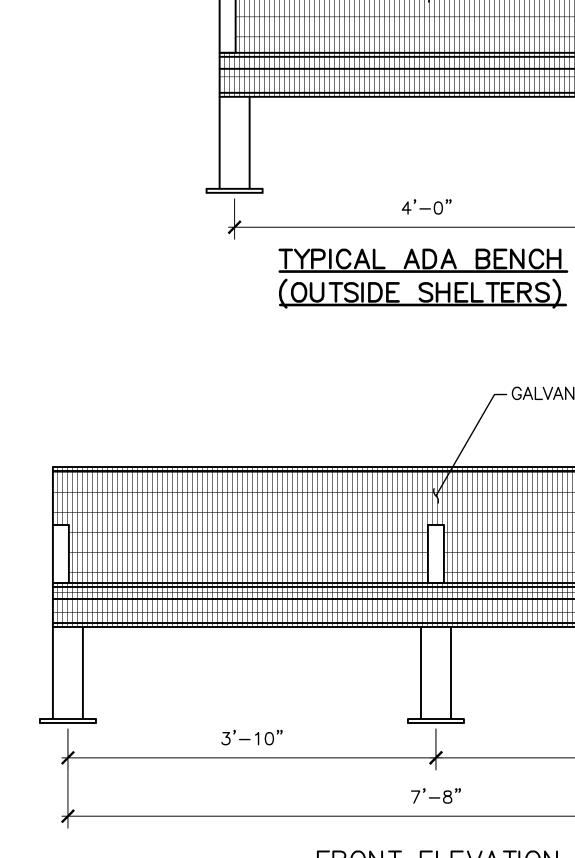


_GALVANIZED STEEL, POWDER COATED BROWN 3'-10" 3'-10" 7'-8" FRONT ELEVATION

4'-0"

GALVANIZED STEEL, POWDER COATED BLUE


BOLTED TO PLATFORM WITH GALVANIZED HARDWARE (TYP)

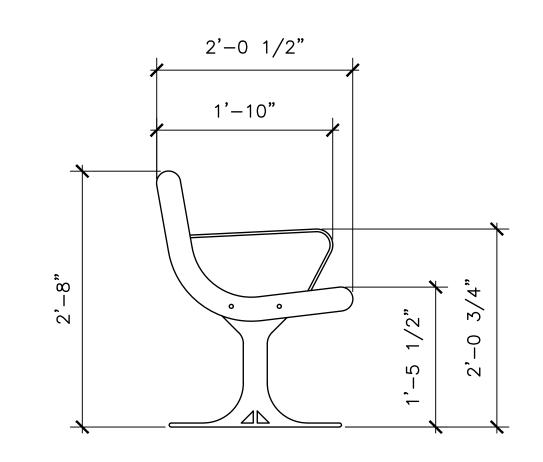



SIDE ELEVATION

TYPICAL PLATFORM BENCH DETAIL (OUTSIDE SHELTERS)


				PENINSULA CORRIDOR JOINT PO	WERS BOARD	ENGINEERING STANDARD DRAWINGS	
				Bin Zhang	Caltrain	STATIONS AND FACILITIES SHELTERS AND AMENITIES	REV: EDITION: FIFTH SCALE: NTS
010126 REV DATE BY	CHK APP DESCRIPTION	REV DATE BY CHK	APP	DIRECTOR, ENGINEERING		BENCHES AND TRASH RECEPTACLES	STANDARD DRAWING NO.: SD-3220

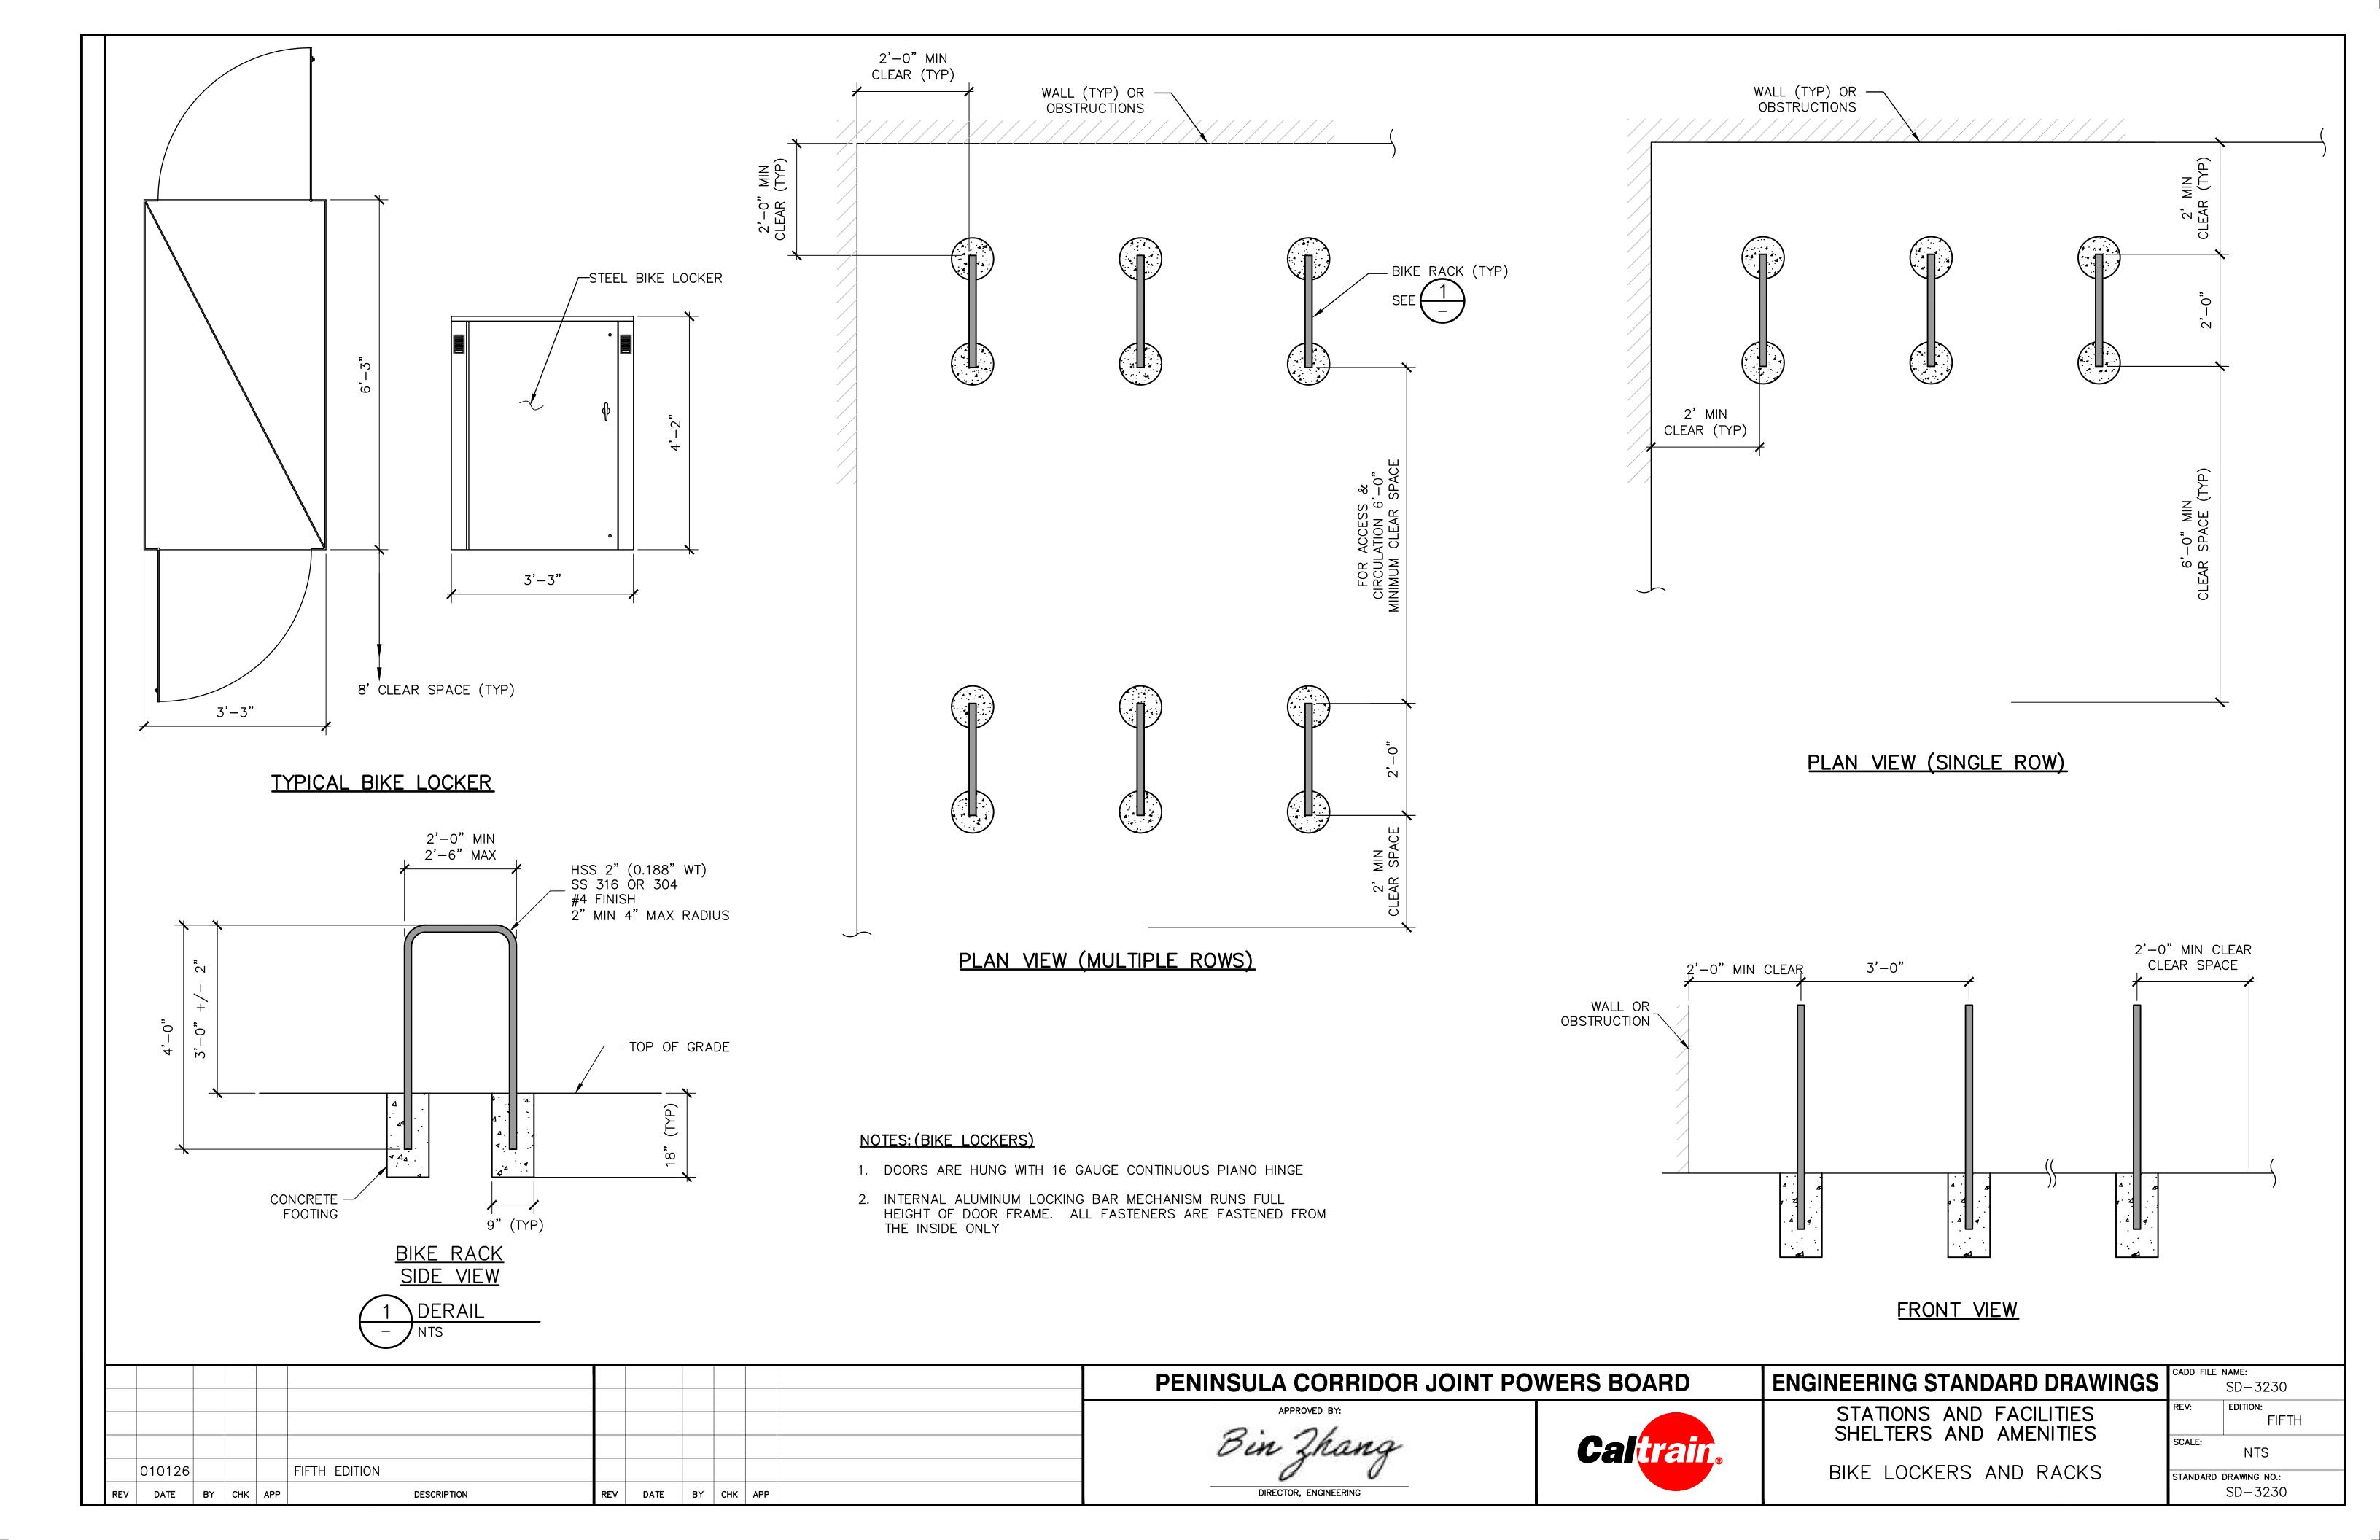

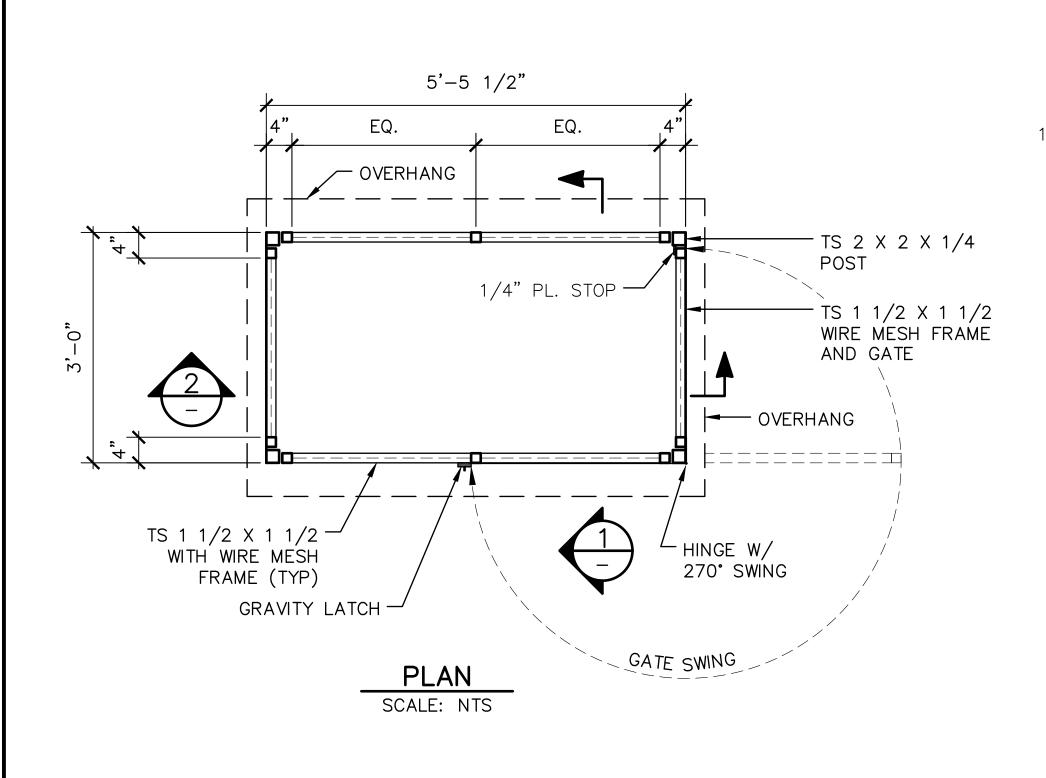

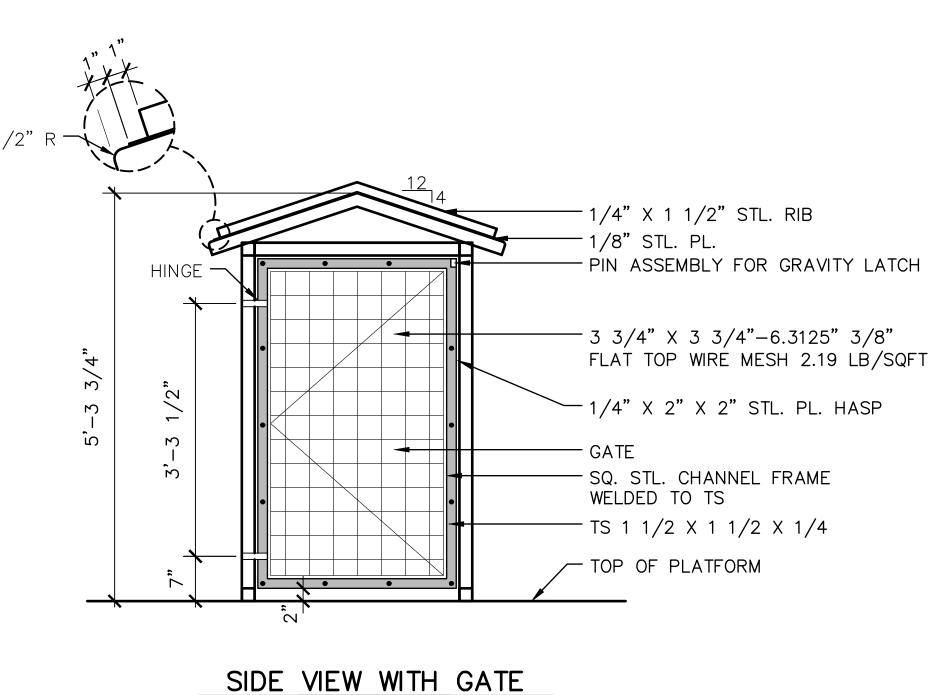


SCALE: NTS

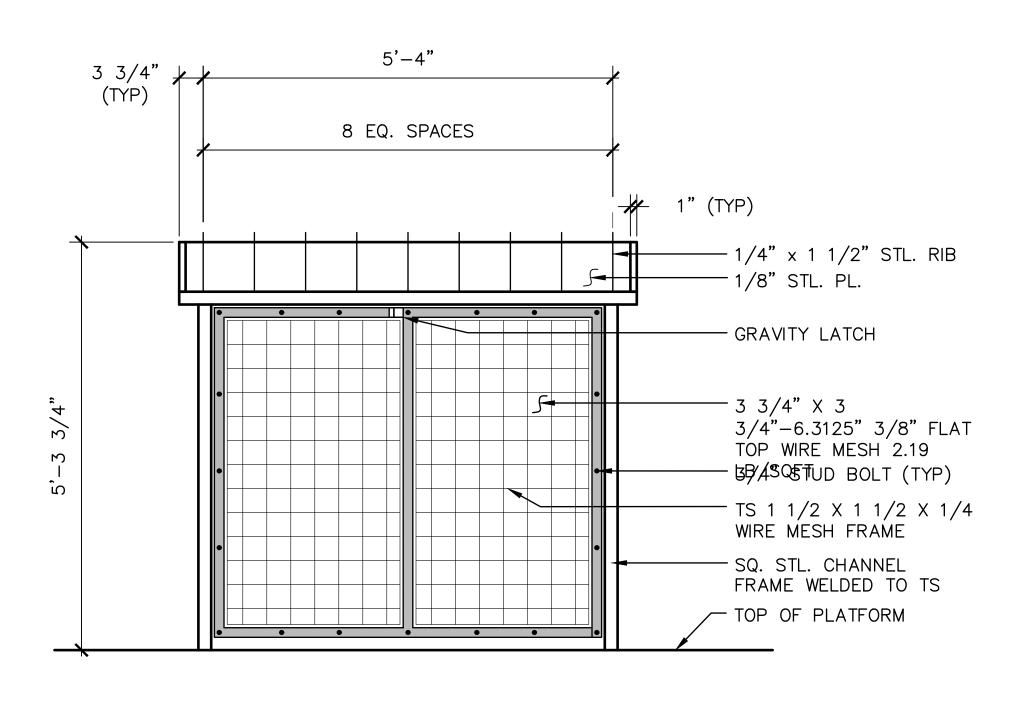


FRONT VIEW
SCALE: NTS

NOTES:

- 1. POSTS ARE SECURED IN POST SLEEVES (BOLTED ON PLATFORMS). GALVANIZED SLEEVES AND HARDWARE.
- 2. ALL METAL SHALL BE HOT DIPPED GALVANIZED AFTER FABRICATION.
- 3. ALL WELDS SHALL BE GROUND SMOOTH.
- 4. ALL SCREWS SHALL BE FLUSH VANDAL PROOF.
- 5. PROVIDE SAMPLE OF GRAVITY LATCH FOR REVIEW AND APPROVAL.

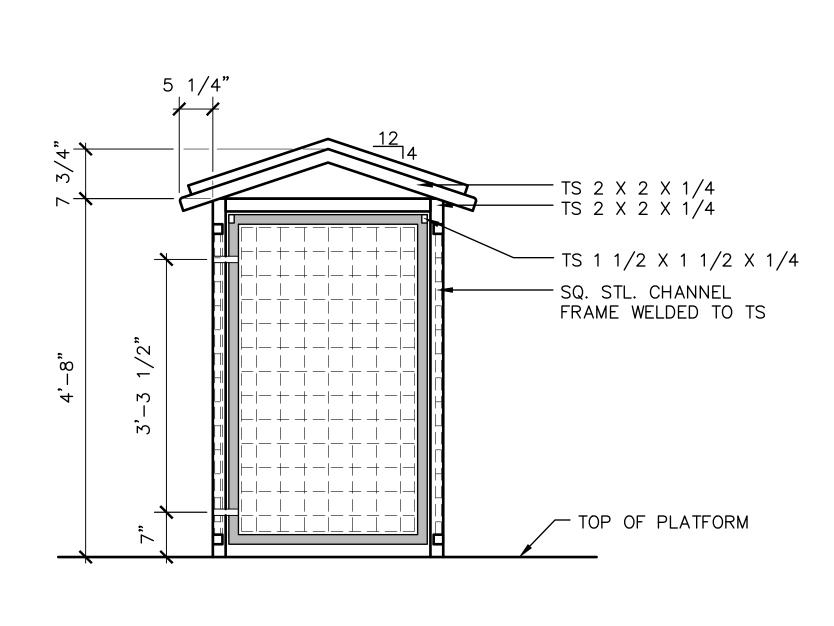



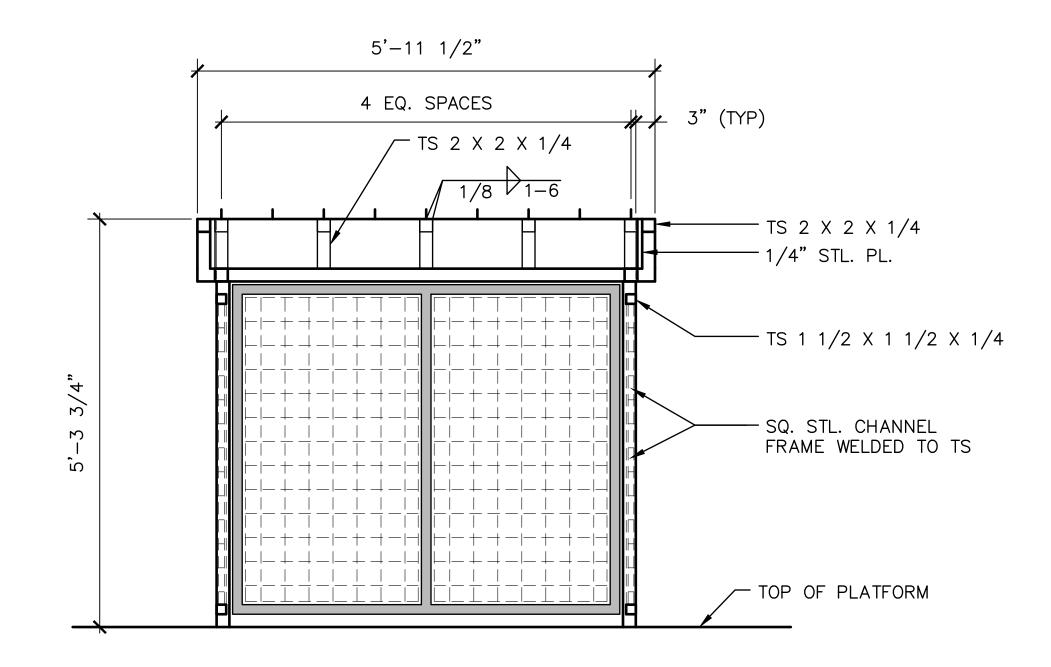

2 SECTION
- NTS

	PENINSULA CORRIDOR JOINT POW	VERS BOARD	ENGINEERING STANDARD DRAWINGS	CADD FILE NAME: SD-3240
	Bin Zhang	Calirain	STATIONS AND FACILITIES SHELTERS AND AMENITIES	REV: EDITION: FIFTH SCALE: NTS
O10126 FIFTH EDITION REV DATE BY CHK APP DESCRIPTION REV DATE BY CHK APP	DIRECTOR, ENGINEERING		WHEEL CHAIR LIFT SHED	STANDARD DRAWING NO.: SD-3240

SIGN AND MARKING SCHEDULE - STATIONS AND FACILITIES

ITEM	SIGN NO	DESCRIPTION	STD DWG	SIZE (W X H)	NOTE	ITEM	SIGN NO
	0.011 110	STATION IDENTIFIER (ID SERIES)	0.0 000	5122 (11 / 11)	11012	. ,	0.011 110
1	ID-1	STATION ID — ON LIGHT POLES	SD-3310	3'-0" X 10"		1	PK-1
2	ID-2	STATION ID (WITH BRAILE) - ON POSTS	SD-3310	1'-0" X 1'-0"	BRAILE NOT INCLUDED	2	PK-2
3	ID-3A	STATION LOGO — ON SHELTERS (Decal)	SD-3301	1'-8" X 1'-0" (APPROX)	OWNER FURNISHED, CONTRACTOR INSTALL	3	PK-3A
4	ID-3B	STATION ID LOGO — ON MONUMENT (Decal)	SD-3301	1'-3" X 8" (APPROX)	OWNER FURNISHED, CONTRACTOR INSTALL	4	PK-3B
5	ID-4	COMMUTER RAIL LOGO (Decal)	SD-3301	1'-4" X 1'-4" (APPROX)	OWNER FURNISHED, CONTRACTOR INSTALL	5	PK-4A
		OPERATIONS SIGNS (OPS SERIES)		, , ,	·	6	PK-4B
1	OPS-1	INFORMATION DISPLAY CASE	SD-3210	4'-2" X 10"			
2	OPS-2A	SPOT CAB, "SC" TYPE	SD-3320	1'-2" X 11"		1	GC-1
3	OPS-2B	SPOT CAB, "SB" TYPE	SD-3320	1'-2" X 11"		2	GC-2
4	OPS-2C	SPOT CAB, "SC 6" TYPE	SD-3320	1'-2" X 11"			
5	OPS-2D	SPOT CAB, "SB 6" TYPE	SD-3320	1'-2" X 11"			<u>GENERA</u>
6	OPS-4	TICKETS ON TVM SHELTERS	SD-3202 AND SD-3205	23" X 5" (APPROX)	DECAL, OWNER FURNISHED, CONTRACTOR INSTALL		ALL SIGN
		BOARDING ASSISTANCE SIGNS (BA SERIES)					STANDAF
1	BA-1	BOARDING ASSISTANCE AREA	SD-3330	1'-0" X 1'-6"			1. CALT
2	BA-2	BENCH CARD	SD-3330	1'-0" X 6"			
3	BA-3	BOARDING ASSISTANCE AREA	SD-3330	6'-0" X 4'-0"	STENCIL MARKING		2. CAL
4	BA-4	WHEELCHAIR SYMBOL	SD-3330	6'-0" X 4'-0"	STENCIL MARKING		3. CALT
5	BA-5	BOARDING GUIDELINES	SD-3330	8 1/2" X 1'-2"	DOUBLE SIDED DECAL APPLIED TO SHELTER GLASS		4. CALT
		STATION DIRECTIONAL SIGNS (DIR SERIES)					5. SIGN
1	DIR-1A, 1B	STATION DIRECTIONAL SIGN TYPE 1	SD-3340	5'-6" X 2'-6"			• (
2	DIR-2A, 2B	STATION DIRECTIONAL SIGN TYPE 2	SD-3340	5'-6" X 2'-6"			
3	DIR-3A, 3B	STATION DIRECTIONAL SIGN TYPE 3	SD-3340	2'-0" X 10"			• (
	RI	EGULATORY AND WARNING SIGNS (RW SERIES)					
1	RW-1	CAUTION: EXPRESS TRAINS	SD-3350	5'-6" X 2'-6"			6. FON
2	RW-2	NO FUN SIGN	SD-3350	4'-6" X 1'-6"			7. OVEF
3	RW-3	WARNING: LOOK BEFORE CROSSING	SD-3350	1'-6" X 1'-6"			8. RETR
4	RW-4	NO TRESPASSING/SUICIDE PREVENTION	SD-3352	2'-0" X 1'-6"	DOUBLE SIDED		
5	RW-5A	KEEP RIGHT	SD-3352	1'-4" X 2'-6"			9. METH
6	RW-5B	KEEP LEFT	SD-3352	1'-4" X 2'-6"			10. FOLL
7	RW-6A	YELLOW SAFETY STRIPING	SD-3502	6" HIGH LETTERS	STENCIL MARKING		
8	RW-6B	YELLOW SAFETY STRIPING (TERMINAL STATIONS)	SD-3502	6" HIGH LETTERS	STENCIL MARKING		• 3
9	RW-6C	WARNING MARKING ON MINI-HIGH PLATFORMS	SD-3502	6" HIGH LETTERS	STENCIL MARKING		• (
10	RW-6D	WAIT BEHIND YELLOW TILES ON MINI-HIGH PLATFORMS	SD-3502	6" HIGH LETTERS	STENCIL MARKING		• (
		PROOF OF PAYMENT SIGNS (POP SERIES)	T				11. GRAF
1	POP-2A	POP ON PLATFORM	SD-3351	1'-6" X 2'-0"			12. FOR
2	POP-2B	POP ON CENTER FENCE	SD-3351	5'-6" X 2'-6"			• 1
		WAYFINDING SIGNS (WF SERIES)	T				• F
1	WF-1A	MONUMENT STATION SITE SIGN	SD-3360	3'-0" X 4'-0"			13. ALL
2	WF-1B	STATION ID ON OVERPASS	SD-3362	VARIES			14. MOU
3	WF-2	VEHICULAR DIRECTIONAL	SD-3361	4'-0" X 1'-0"			
4	WF-3A	BOARDING AREA DIRECTIONAL	SD-3361	1'-9" X 1'-9"			15. FOR
5	WF-3B	EXTERIOR PATHWAY DIRECTIONAL	SD-3361	1'-9" X 1'-9" AND 1'-9" X 10 1/2"			16. THES
6	WF-5A	ELEVATOR WAYFINDING (FRONT SIDE)	SD-3362	1'-9" X 1'-9"			REQI
7	WF-5B	ELEVATOR WAYFINDING (BACK SIDE)	SD-3362				17. CON
8	WF-5C	ELEVATOR WAYFINDING (LEFT ARROW)	SD-3362				18. STRU
9	WF-5D	ELEVATOR WAYFINDING (RIGHT ARROW)	SD-3362				PRES SHAL

GENERAL SIGN REQUIREMENTS:

EMERGENCY EXIT

ALL SIGNS SHALL COMPLY WITH THE FOLLOWING GENERAL REQUIREMENTS UNLESS NOTED OTHERWISE IN THE INDIVIDUAL STANDARD DRAWINGS.

STD DWG

SD-3380

SD-3380

SD-3381

SD-3381

SD-3381

SD-3381

SD-7006

SD-7006

SIZE (W X H)

2'-0" X 5'-0"

2'-0" X 3'-0"

1'-0" X 1'-6"

2'-0" X 3'-0"

1'-0" X 1'-6"

2'-0" X 3'-0"

2'-6" X 1'-0"

2'-6" X 1'-0"

NOTE

- 1. CALTRAIN WILL PROVIDE ARTWORK FOR ALL CALTRAIN (STATIONS AND FACILITIES, AND GRADE CROSSINGS) SIGNS FOR FABRICATION BY CONTRACTOR. SUBMIT PDF PROOF TO CALTRAIN FOR APPROVAL PRIOR TO FABRICATION.
- 2. CALTRAIN DOES NOT PROVIDE ARTWORK FOR MUTCD SIGNS.

DESCRIPTION

PARKING SIGNS (PK SERIES)

EMPLOYEE & TRAIN OPERATOR PARKING TYPE 1

EMPLOYEE & TRAIN OPERATOR PARKING TYPE 2

GRADE CROSSING SIGNS (GC SERIES)

CALTRAIN EMPLOYEE PARKING TYPE 1

CALTRAIN EMPLOYEE PARKING TYPE 2

DO NOT GO AROUND GATE WHEN DOWN

PARKING TICKET INFORMATION

LOT OPERATOR INFORMATION


- 3. CALTRAIN DOES NOT PROVIDE ARTWORK FOR STENCIL MARKINGS ON PLATFORMS.
- 4. CALTRAIN WILL PROVIDE CORPORATE LOGO UPON REQUEST.
- 5. SIGN PANEL MATERIAL (MINIMUM THICKNESS):
 - 0.080 (ABOUT 0.1" THICK) ALUMINUM 5052 TENSILE STRENGTH (FOR SIGN PANELS UP TO 24" WIDE IN ANY DIMENSION).
 - 0.10 (ABOUT 0.125" THICK) ALUMINUM 5052 TENSILE STRENGTH (FOR SIGN PANELS LARGER THAN 24" IN ANY DIMENSION UP TO 6'-0" IN ANY DIMENSION.
- HELVETICA NEUE 65 MEDIUM UPPER AND LOWER CASE LETTERS UNLESS NOTED OTHERWISE.
- 7. OVERLAY: PROTECTIVE OVERLAY FILM SHALL BE COMPATIBLE WITH RETROREFLECTIVE SHEETING AND AS RECOMMENDED BY ITS MANUFACTURER.
- 8. RETROREFLECTIVE SHEETING: COMPLY WITH ASTM D4956 CLASS I OR HIGHER.
- 9. METHOD: ALL SIGNS SHALL BE SCREEN PRINTED. VINYL LETTERS ARE NOT TO BE USED, EXCEPT WHEN THEY ARE CUT OUT FOR OTHER APPLICATIONS SUCH AS STATION SHELTERS.
- 10. FOLLOW AMS-STD-595 (SUCCESSOR TO FEDERAL STANDARD 595) FOR COLORS:

• SAFETY GREEN: 14109 OR 14066 • SAFETY RED: 11105 OR 11086

• SAFETY YELLOW: 33538

- SAFETY BLUE: 15080 ORANGE: 12243
- 11. GRAFFITI RESISTANCE: APPLY A CLEAR, SEMI-GLOSS TOPCOAT TO ALL SIGN PANELS.
- 12. FOR STENCIL MARKINGS AND STRIPING:
- MARKINGS SHALL BE FULL FOR TEXT AND LETTERS.
- PRIMER: APPLY PRIMER TO FILL SURFACE POROSITY OF CONCRETE.
- APPLY A MINIMUM OF TWO COATS.
- 13. ALL HOLES FOR MOUNTING SHALL BE DRILLED IN THE SHOP.
- 14. MOUNTING HARDWARE: TAMPER PROOF, SS 316.
- 15. FOR SIGNS LOCATED ON RIGHT-OF-WAY (ROW), SEE SD-9000 SERIES DRAWINGS.
- 16. THESE ARE TYPICAL CALTRAIN SIGNS. DESIGNERS SHOULD DEVELOP FOR CALTRAIN'S APPROVAL ADDITIONAL SIGNS AS REQUIRED.
- 17. CONTACT MTC FOR HUB SIGNAGE PROGRAM (HSP) GUIDELINES AND STANDARDS.
- 18. STRUCTURAL MEMBERS AND FOUNDATIONS FOR SIGNS PRESENTED IN THE STANDARD DRAWINGS ARE INTENDED TO PROVIDE A PRESCRIPTIVE DESIGN WITH GENERAL ARRANGEMENT DETAILS, U.N.O., DETAILED STRUCTURAL DESIGN AND CALCULATIONS SHALL BE CONDUCTED FOR EACH INSTALLATION CASE, SELECTING APPROPRIATE COMPONENTS TO CONFORMING TO THE LATEST DESIGN CODE REQUIREMENTS, SUBJECT TO REVIEW AND APPROVAL BY CALTRAIN.

								PENINSULA CORRIDOR JOINT PO	WERS BOARD	ENGINEERING STANDARD DRAWINGS	CADD FILE NAM	ie:)—3300
RE	010126 V DATE	BY CHK APP	FIFTH EDITION DES	SCRIPTION	REV DATE	BY CHK	APP	Bin Zhang DIRECTOR, ENGINEERING	Caltrain	STATIONS AND FACILITIES SIGNAGE SIGN AND MARKING SCHEDULE GENERAL REQUIREMENTS	SCALE: STANDARD DRA	NTS WING NO.: 0-3300

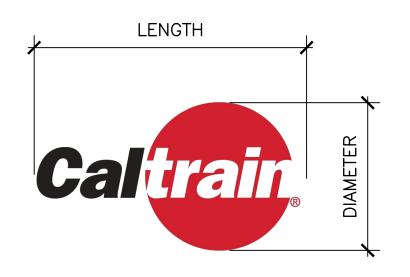

FOR PROPER USAGE SEE THE CALTRAIN GRAPHIC STANDARDS GUIDE

CORPORATE LOGO (Decal) (ID-3A, ID-3B)



COMMUTER RAIL SYMBOL (Decal)
(ID-4)



<u>D9-6</u>

HANDICAPPED ACCESSIBLE



<u>I-7</u>

TRAIN STATION



DO NOT ENTER

<u>R5-1</u>




<u>G93C (CA)</u>

BIKE PARKING



W10-1
HIGHWAY-RAIL GRADE CROSSING
ADVANCE WARNING

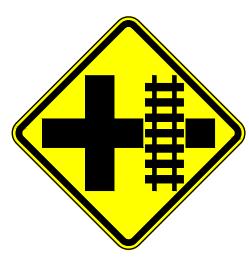

W10-2
HIGHWAY-RAIL GRADE CROSSING ADVANCE WARNING




<u>R8-8</u>

DO NOT STOP ON TRACKS

PAIL CHIO

<u>R15-1</u>

RAILROAD CROSSING

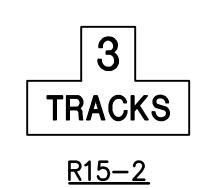

NUMBER OF TRACKS



<u>R15-6</u>

DO NOT DRIVE ON TRACKS SYMBOL



R99 (CA)


HANDICAPPED AND FINE


EXAMPLES OF CALIFORNIA SIGN CHARTS (CA MUTCD)


NOTE:


SEE DRAWINGS IN THE SD-9100 SERIES FOR RIGHT-OF-WAY SIGNAGE.


	PENINSULA CORRIDOR JOINT POW	VERS BOARD	ENGINEERING STANDARD DRAWINGS	CADD FILE	SD-3301
	APPROVED BY:		STATIONS AND FACILITIES	REV:	EDITION: FIFTH
010126 FIFTH EDITION	Oin Thang	Caltrain _®	SIGNAGE EXAMPLES OF	SCALE:	NTS
O10126	DIRECTOR, ENGINEERING		SIGNS AND SYMBOLS	STANDARD	D DRAWING NO.: SD-3301

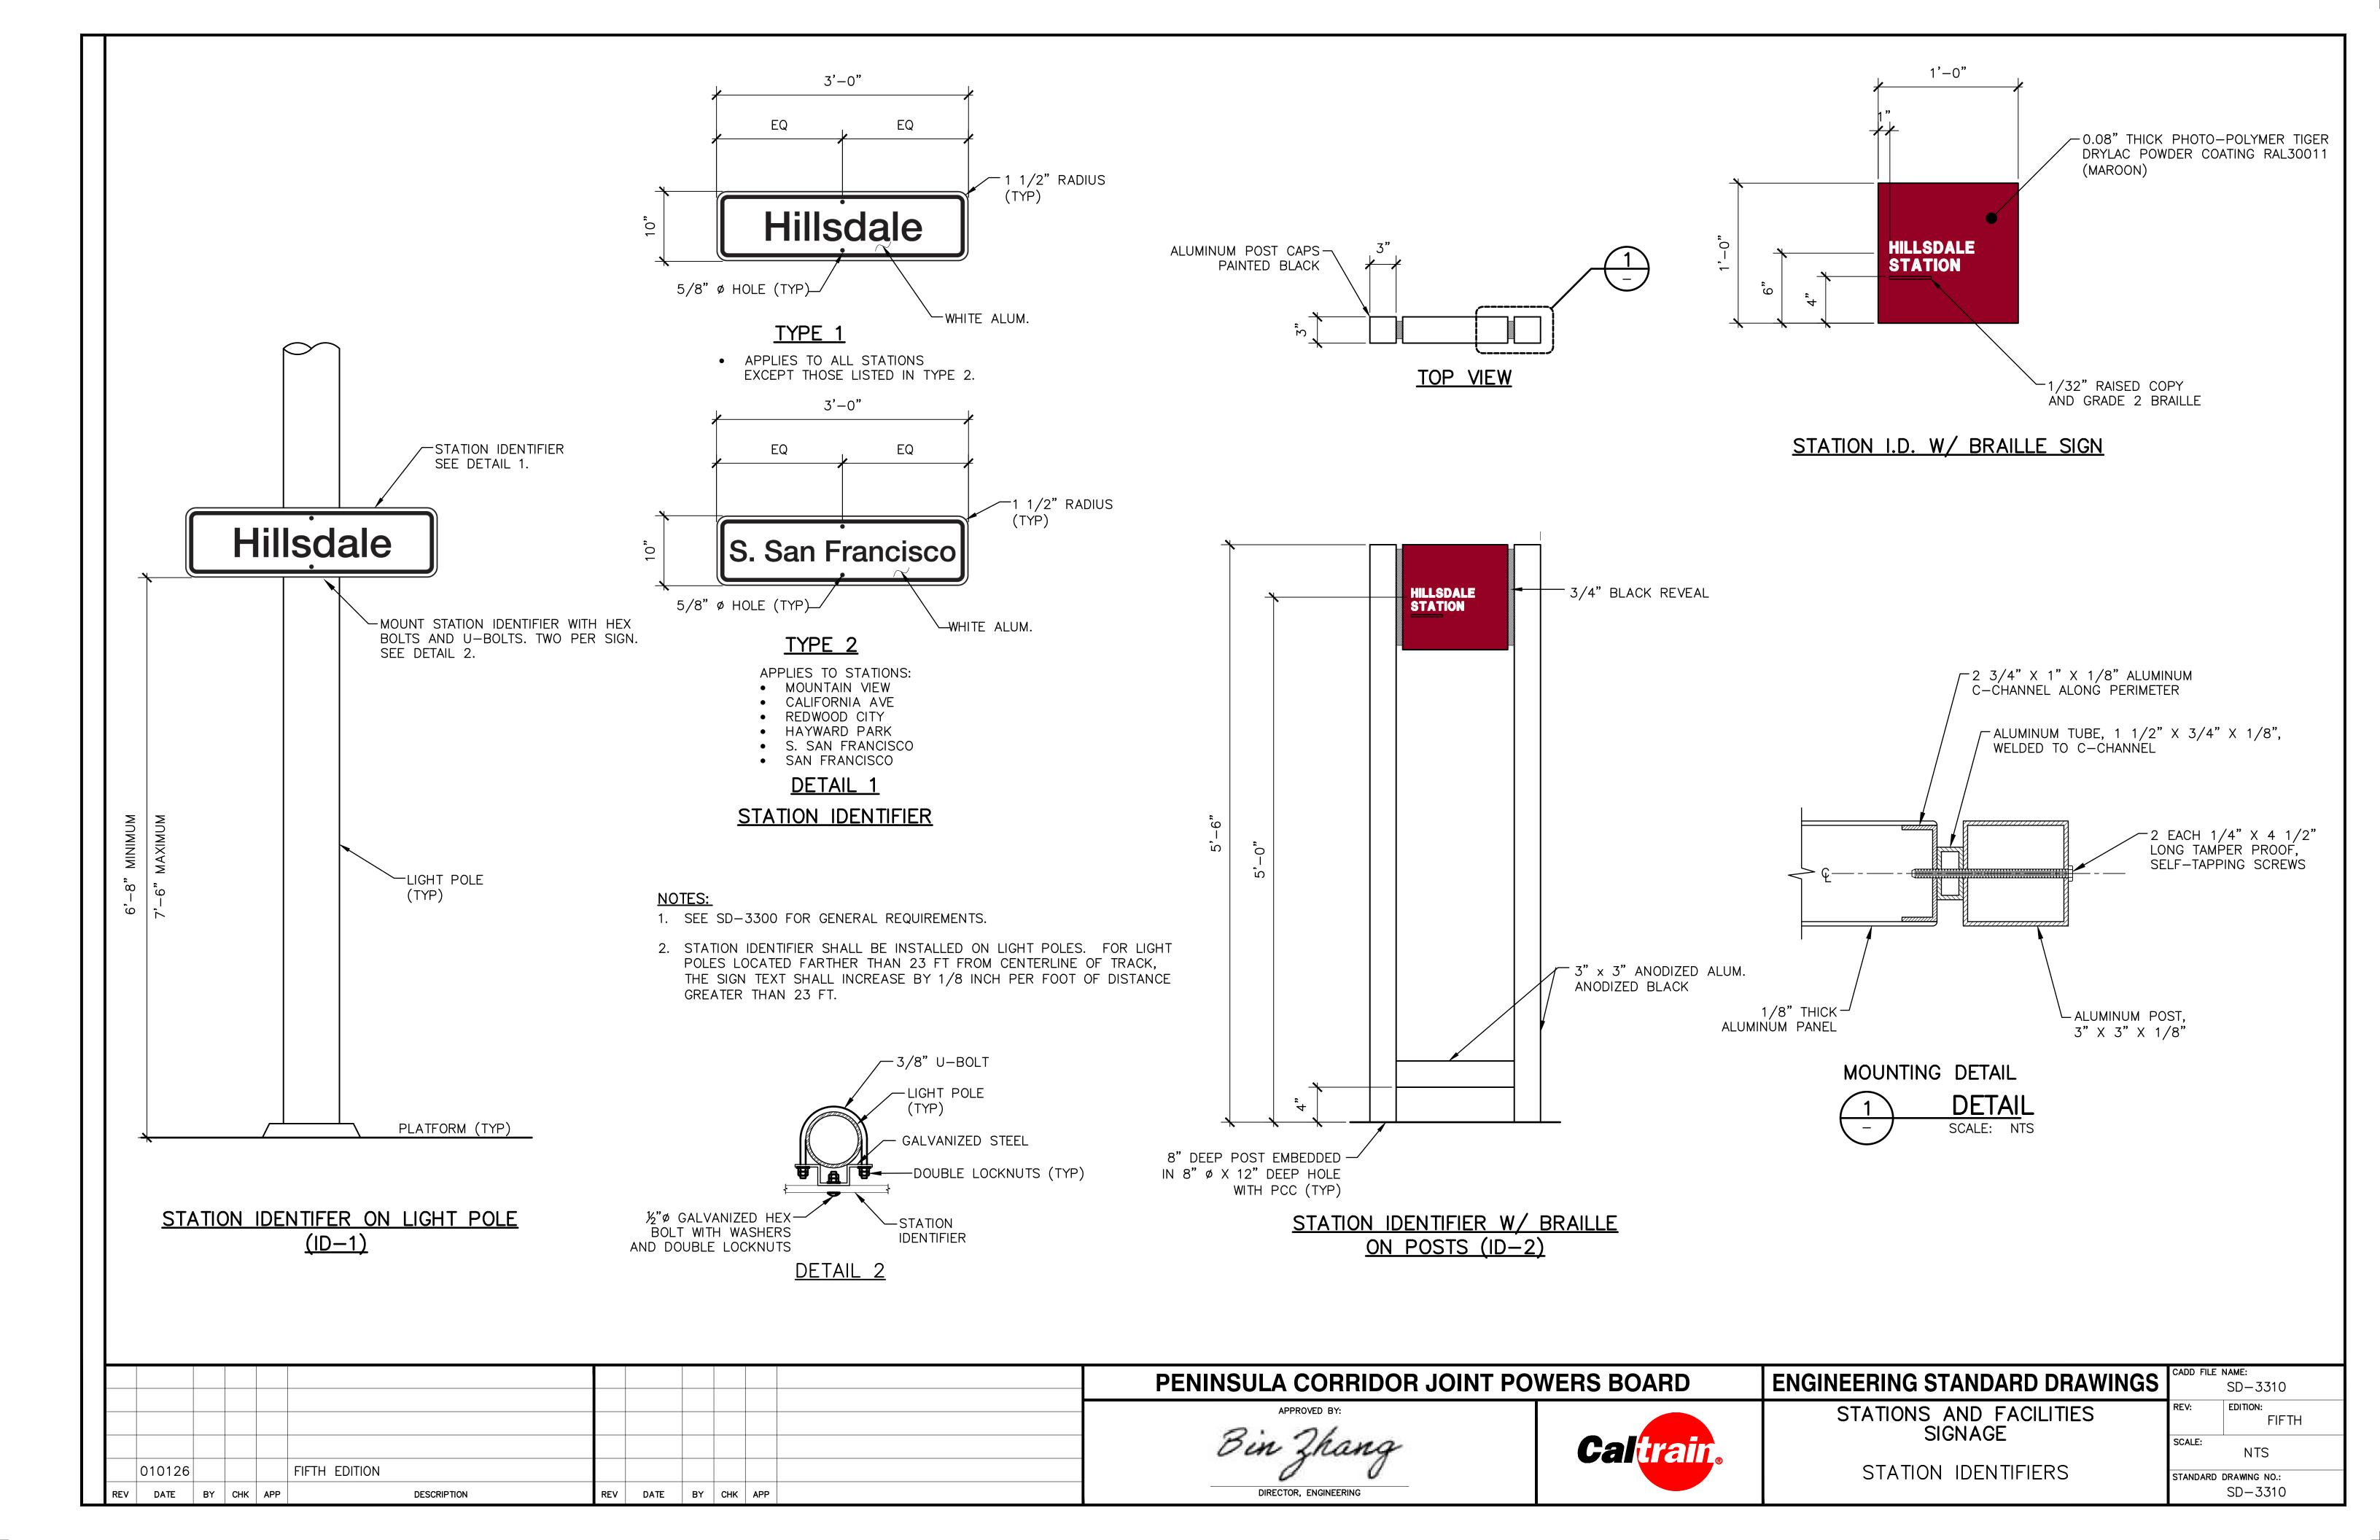


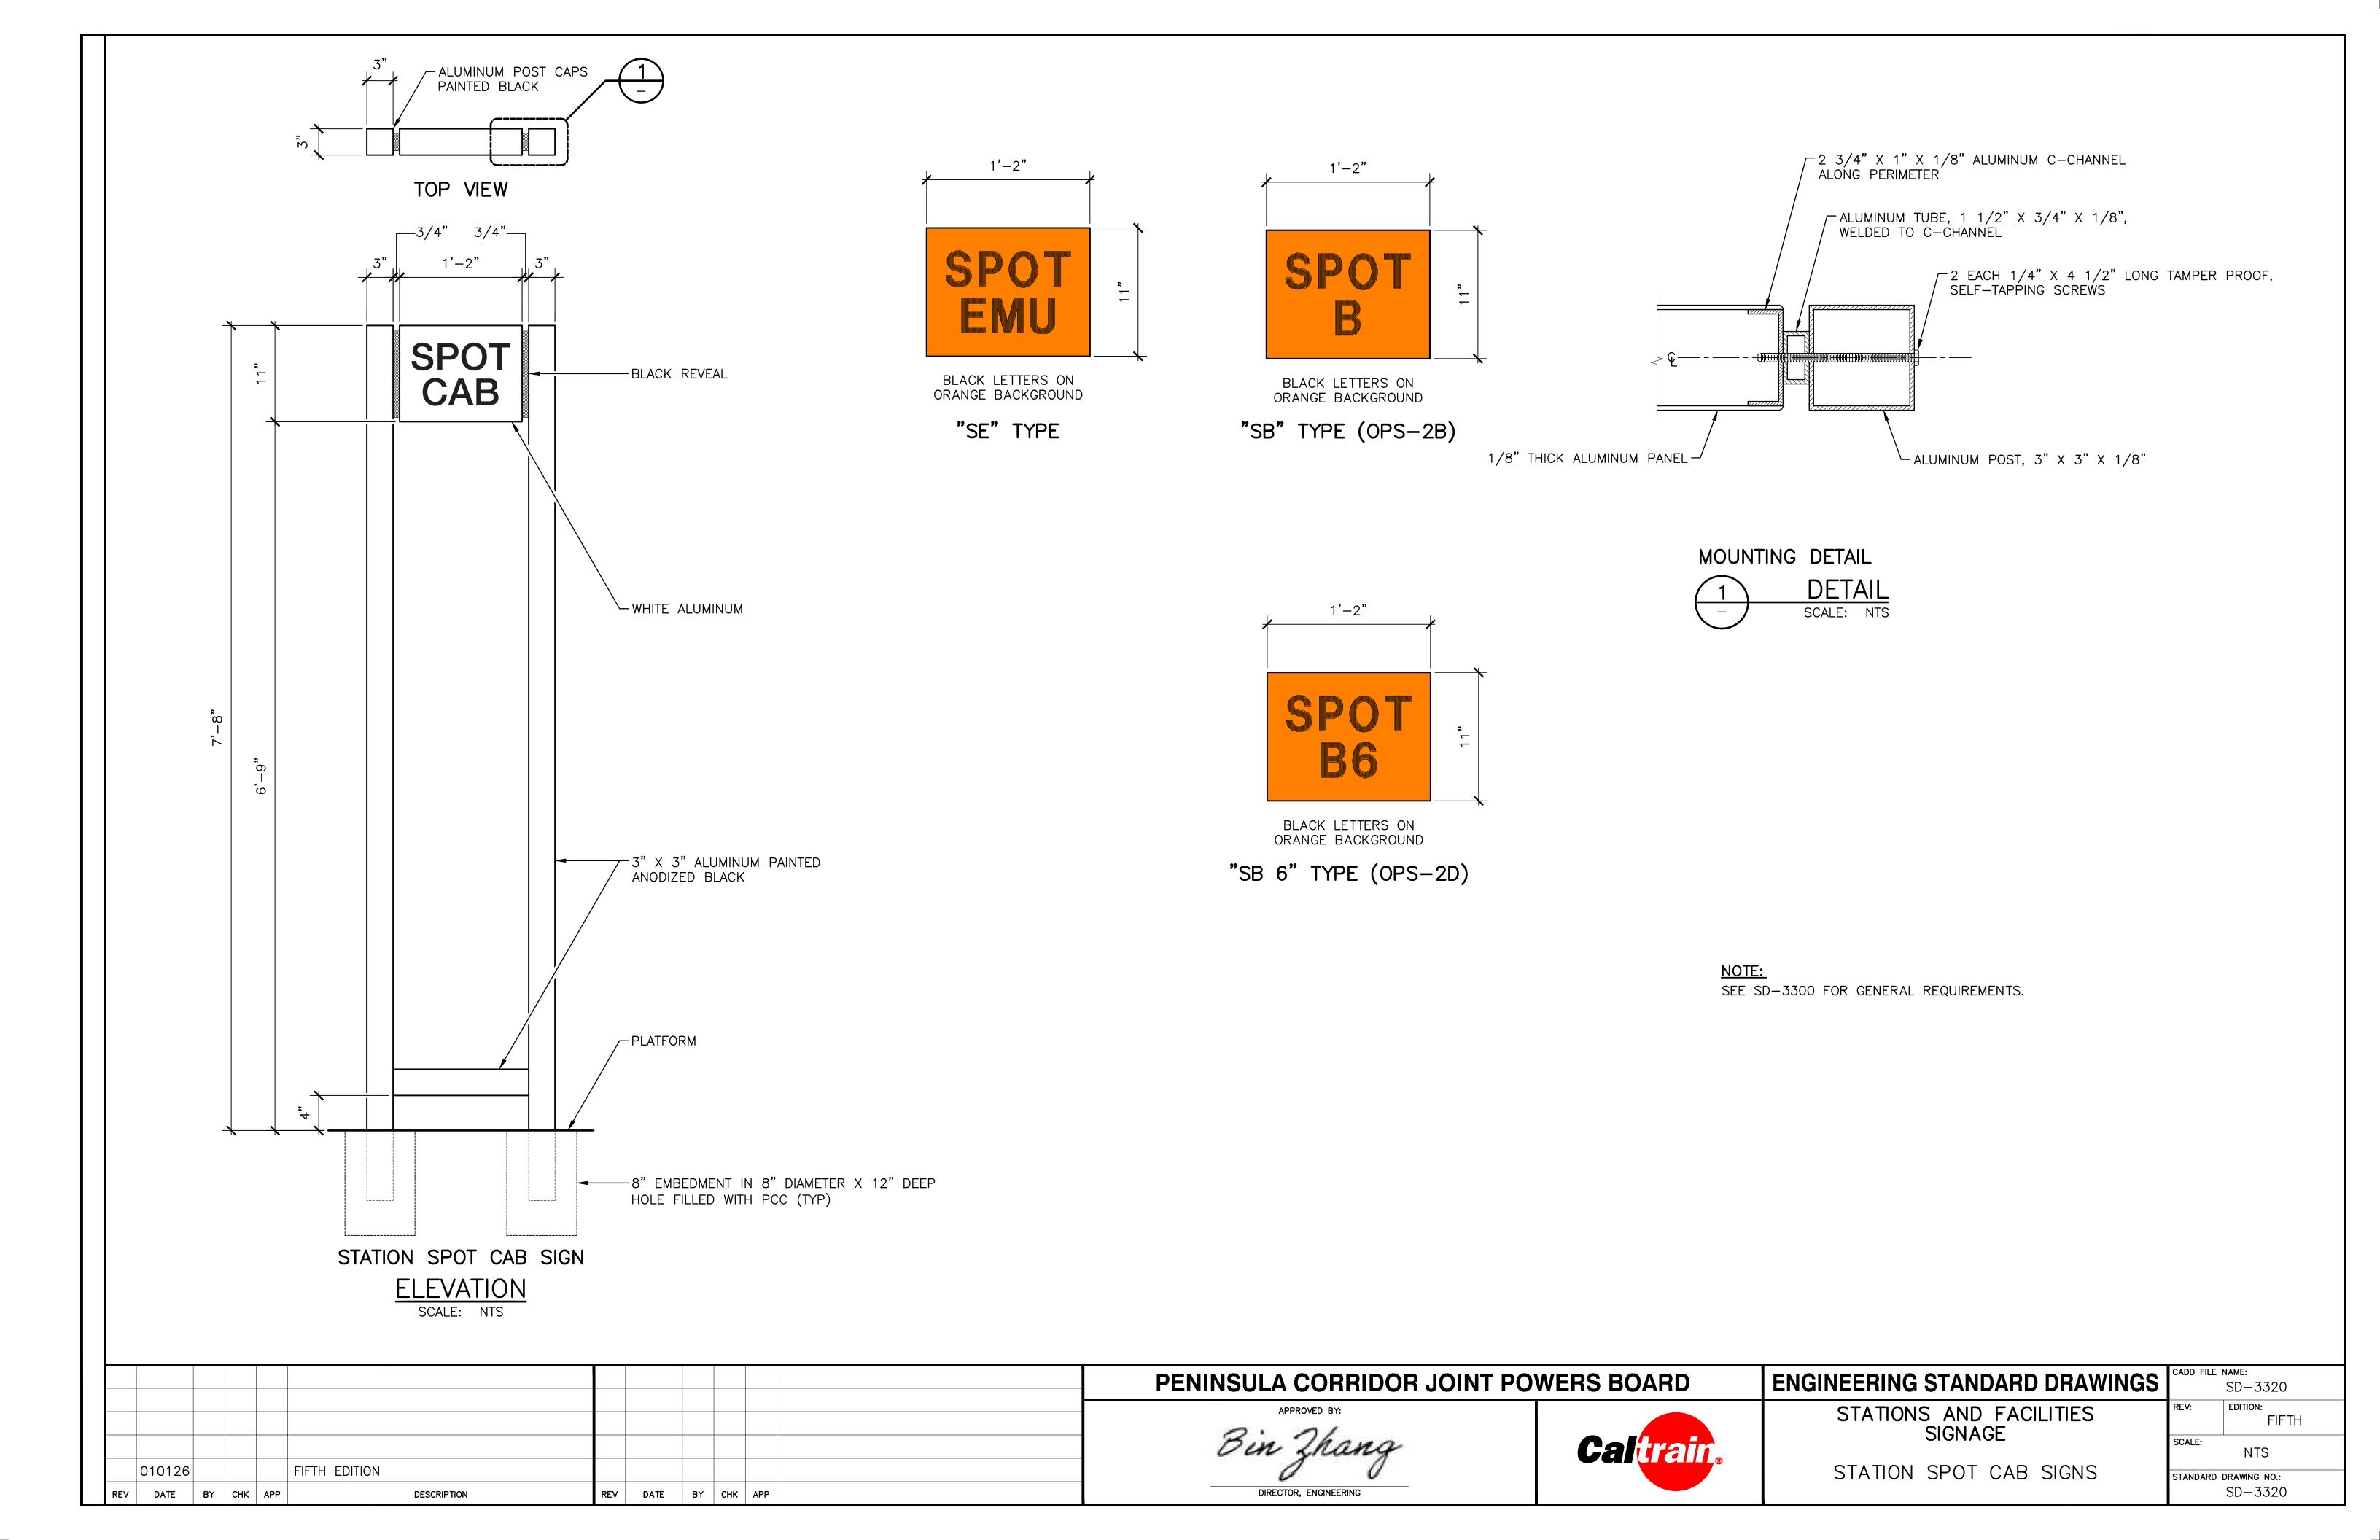

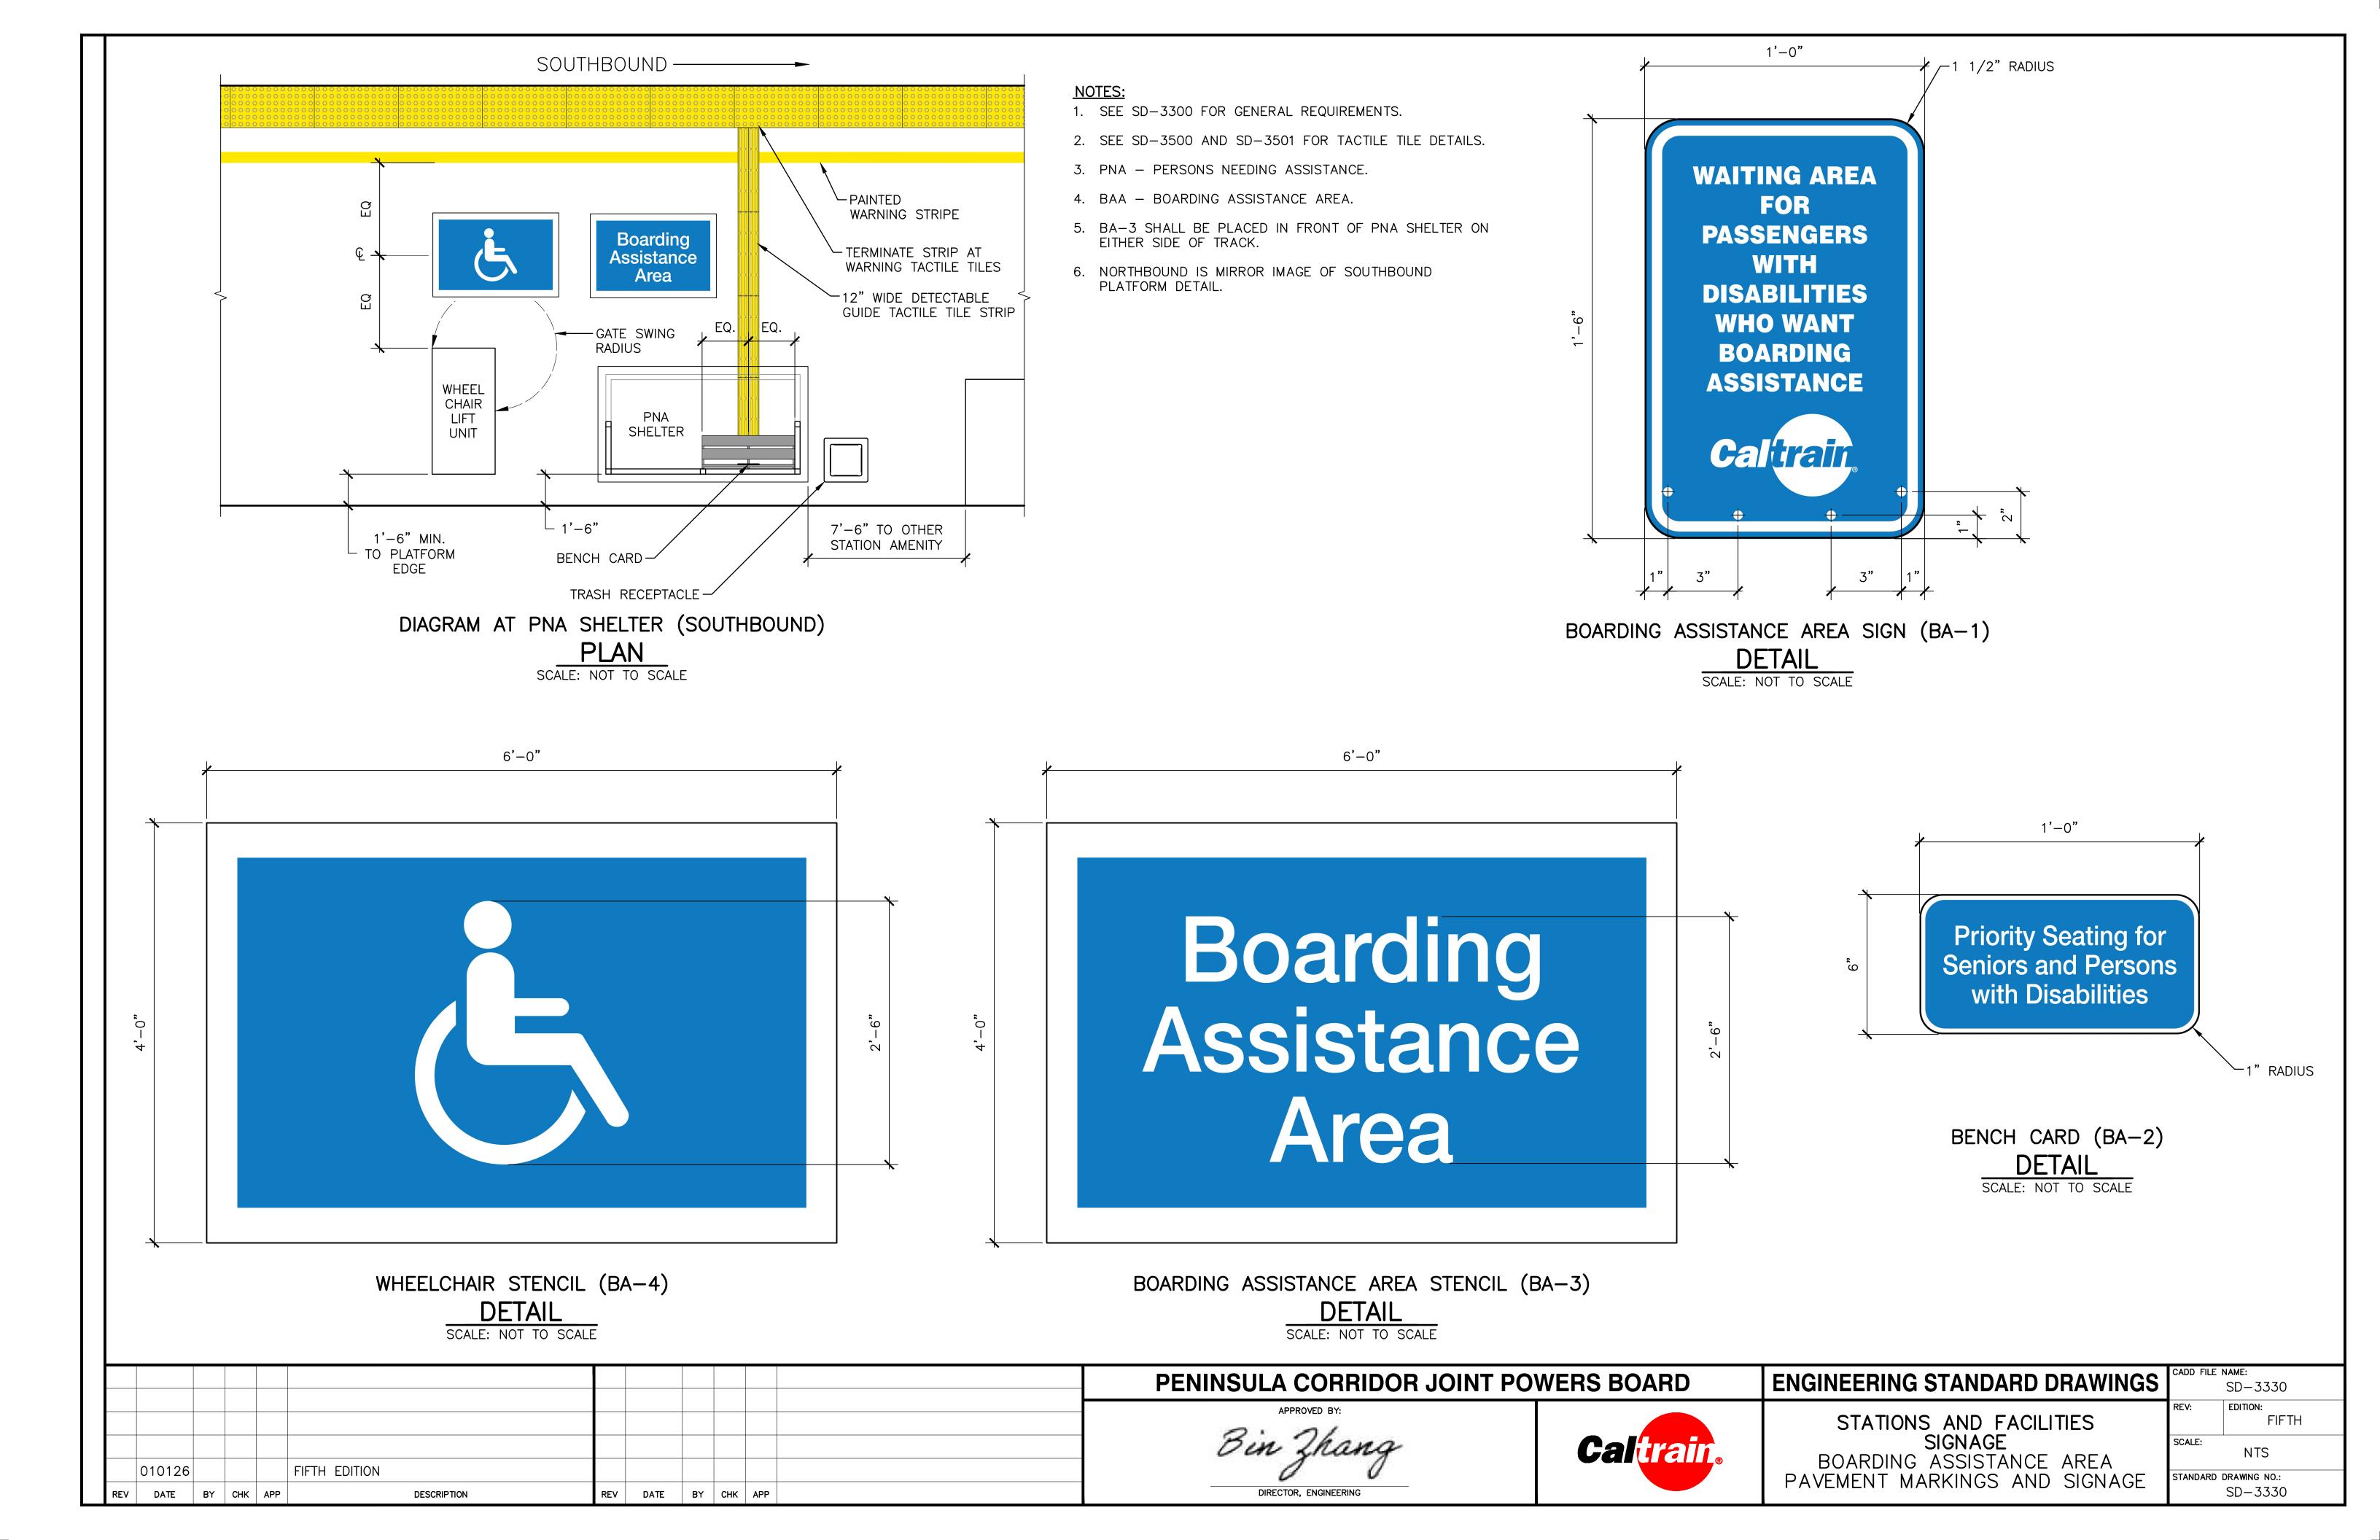

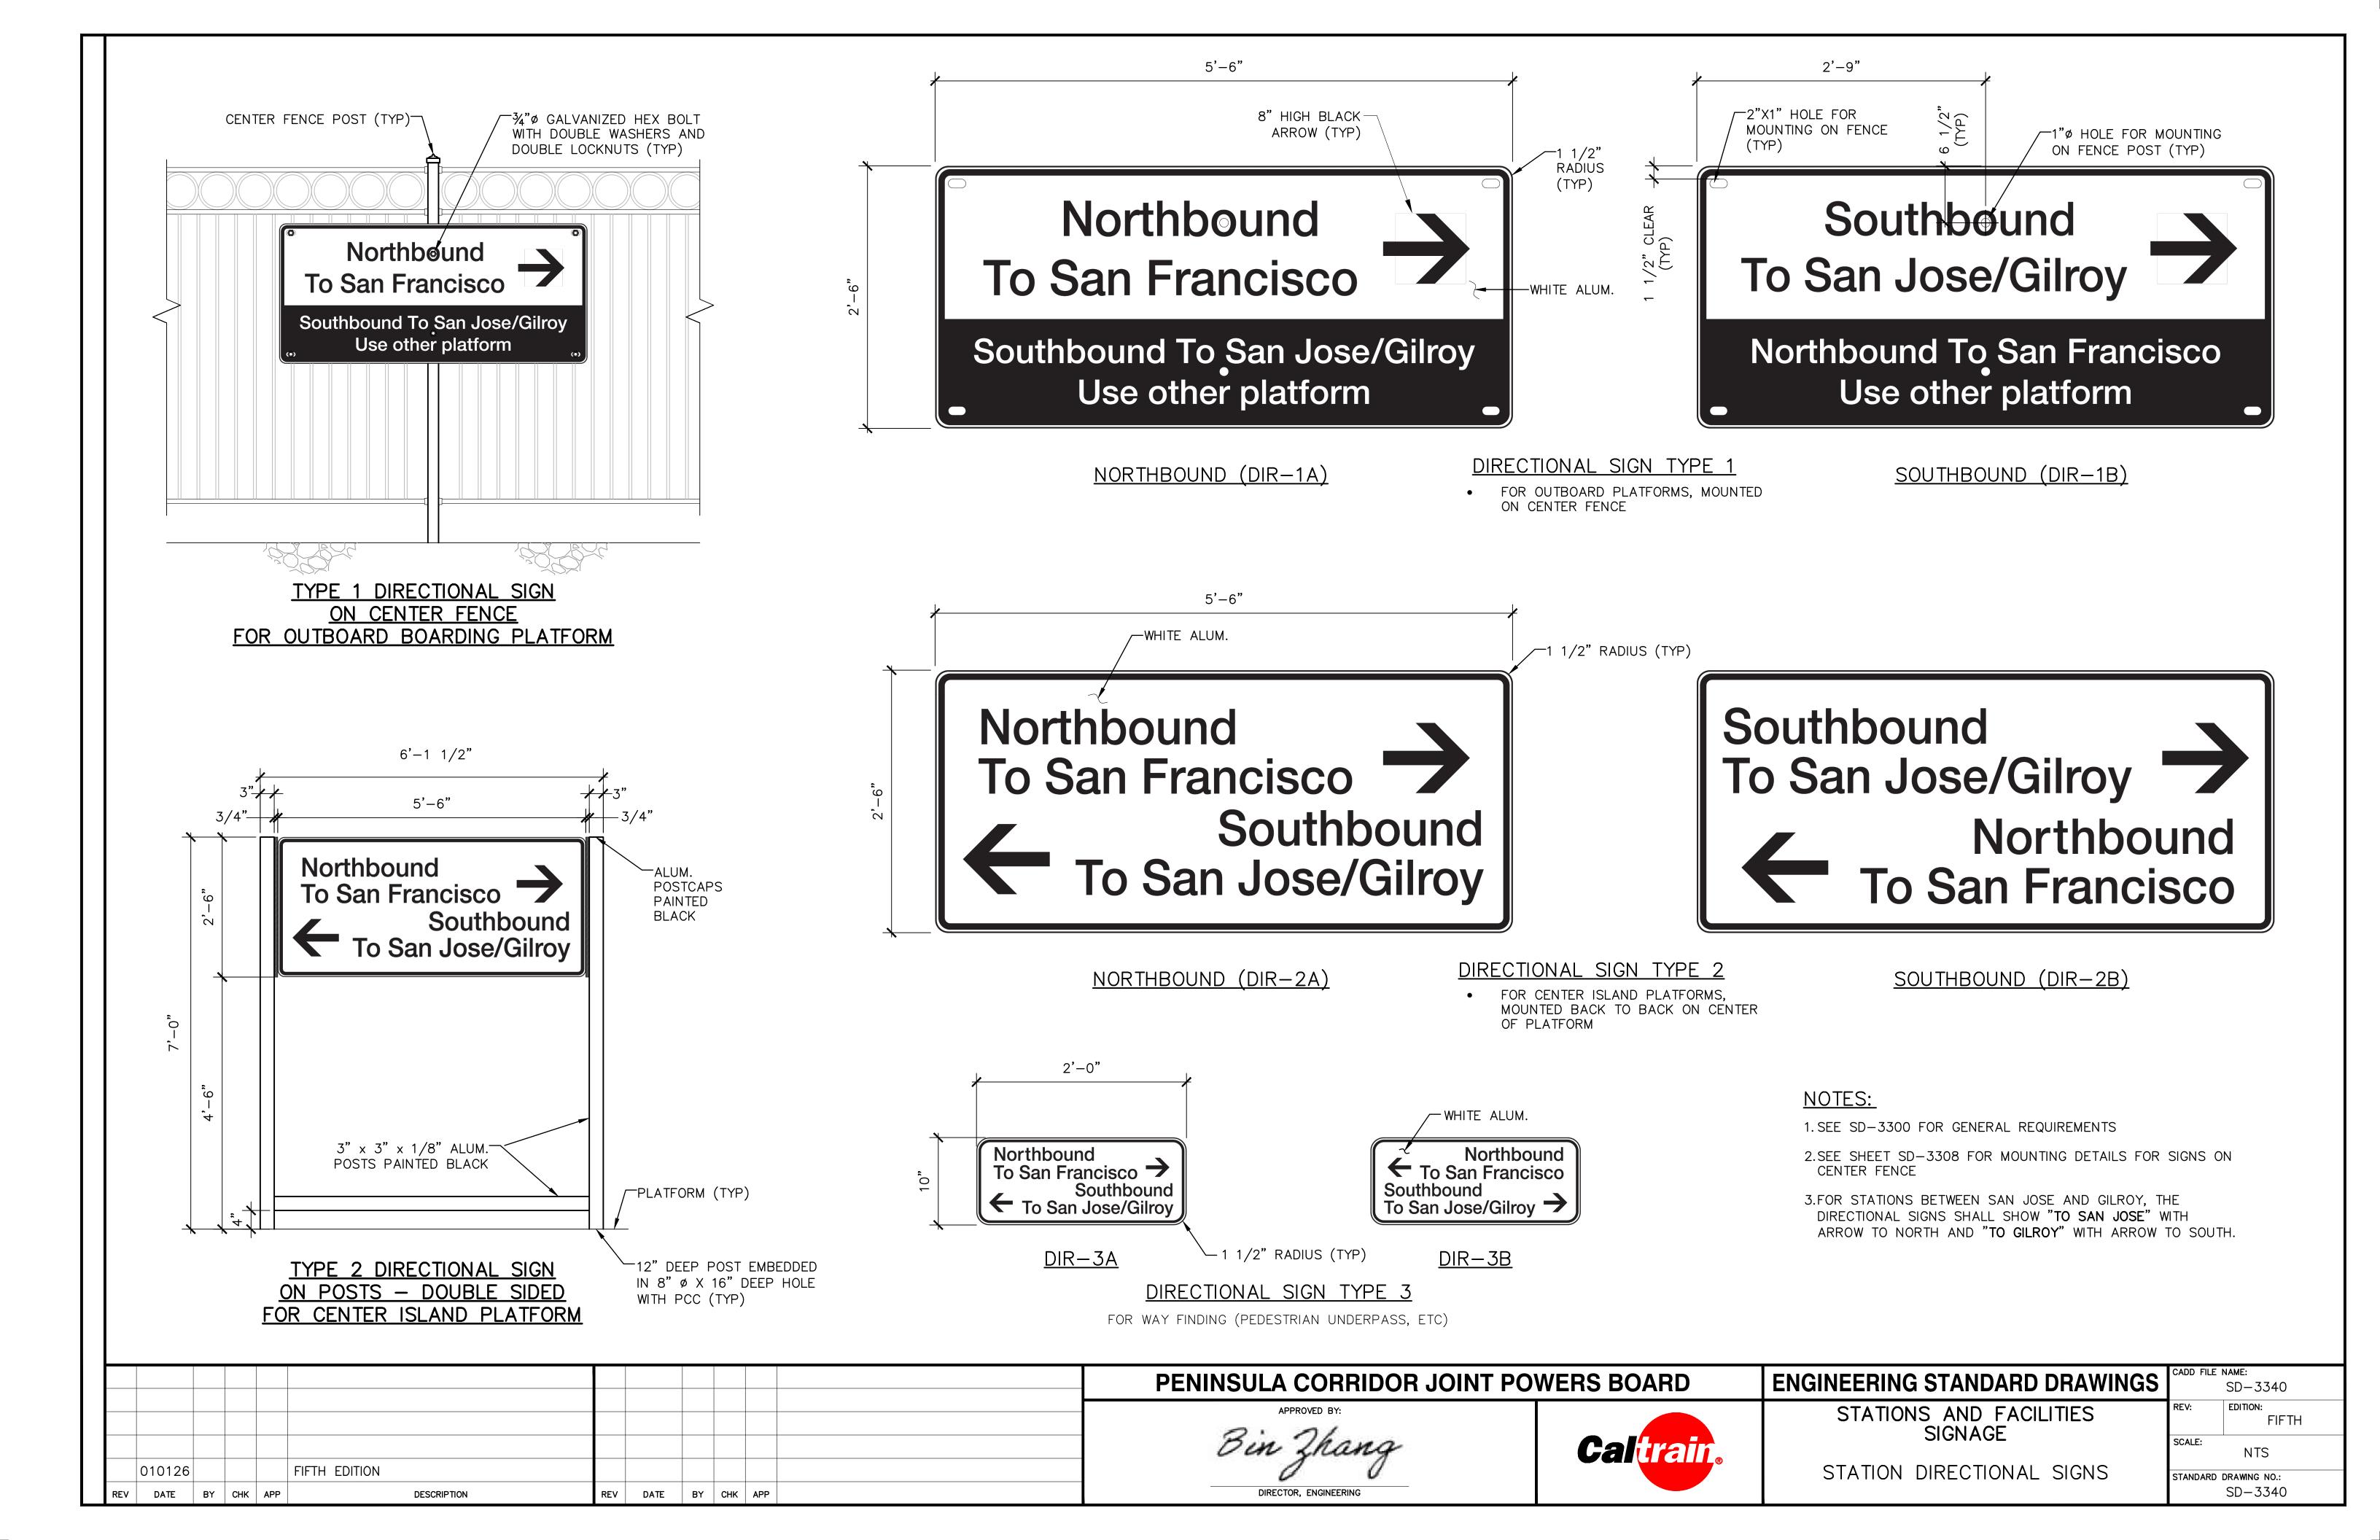

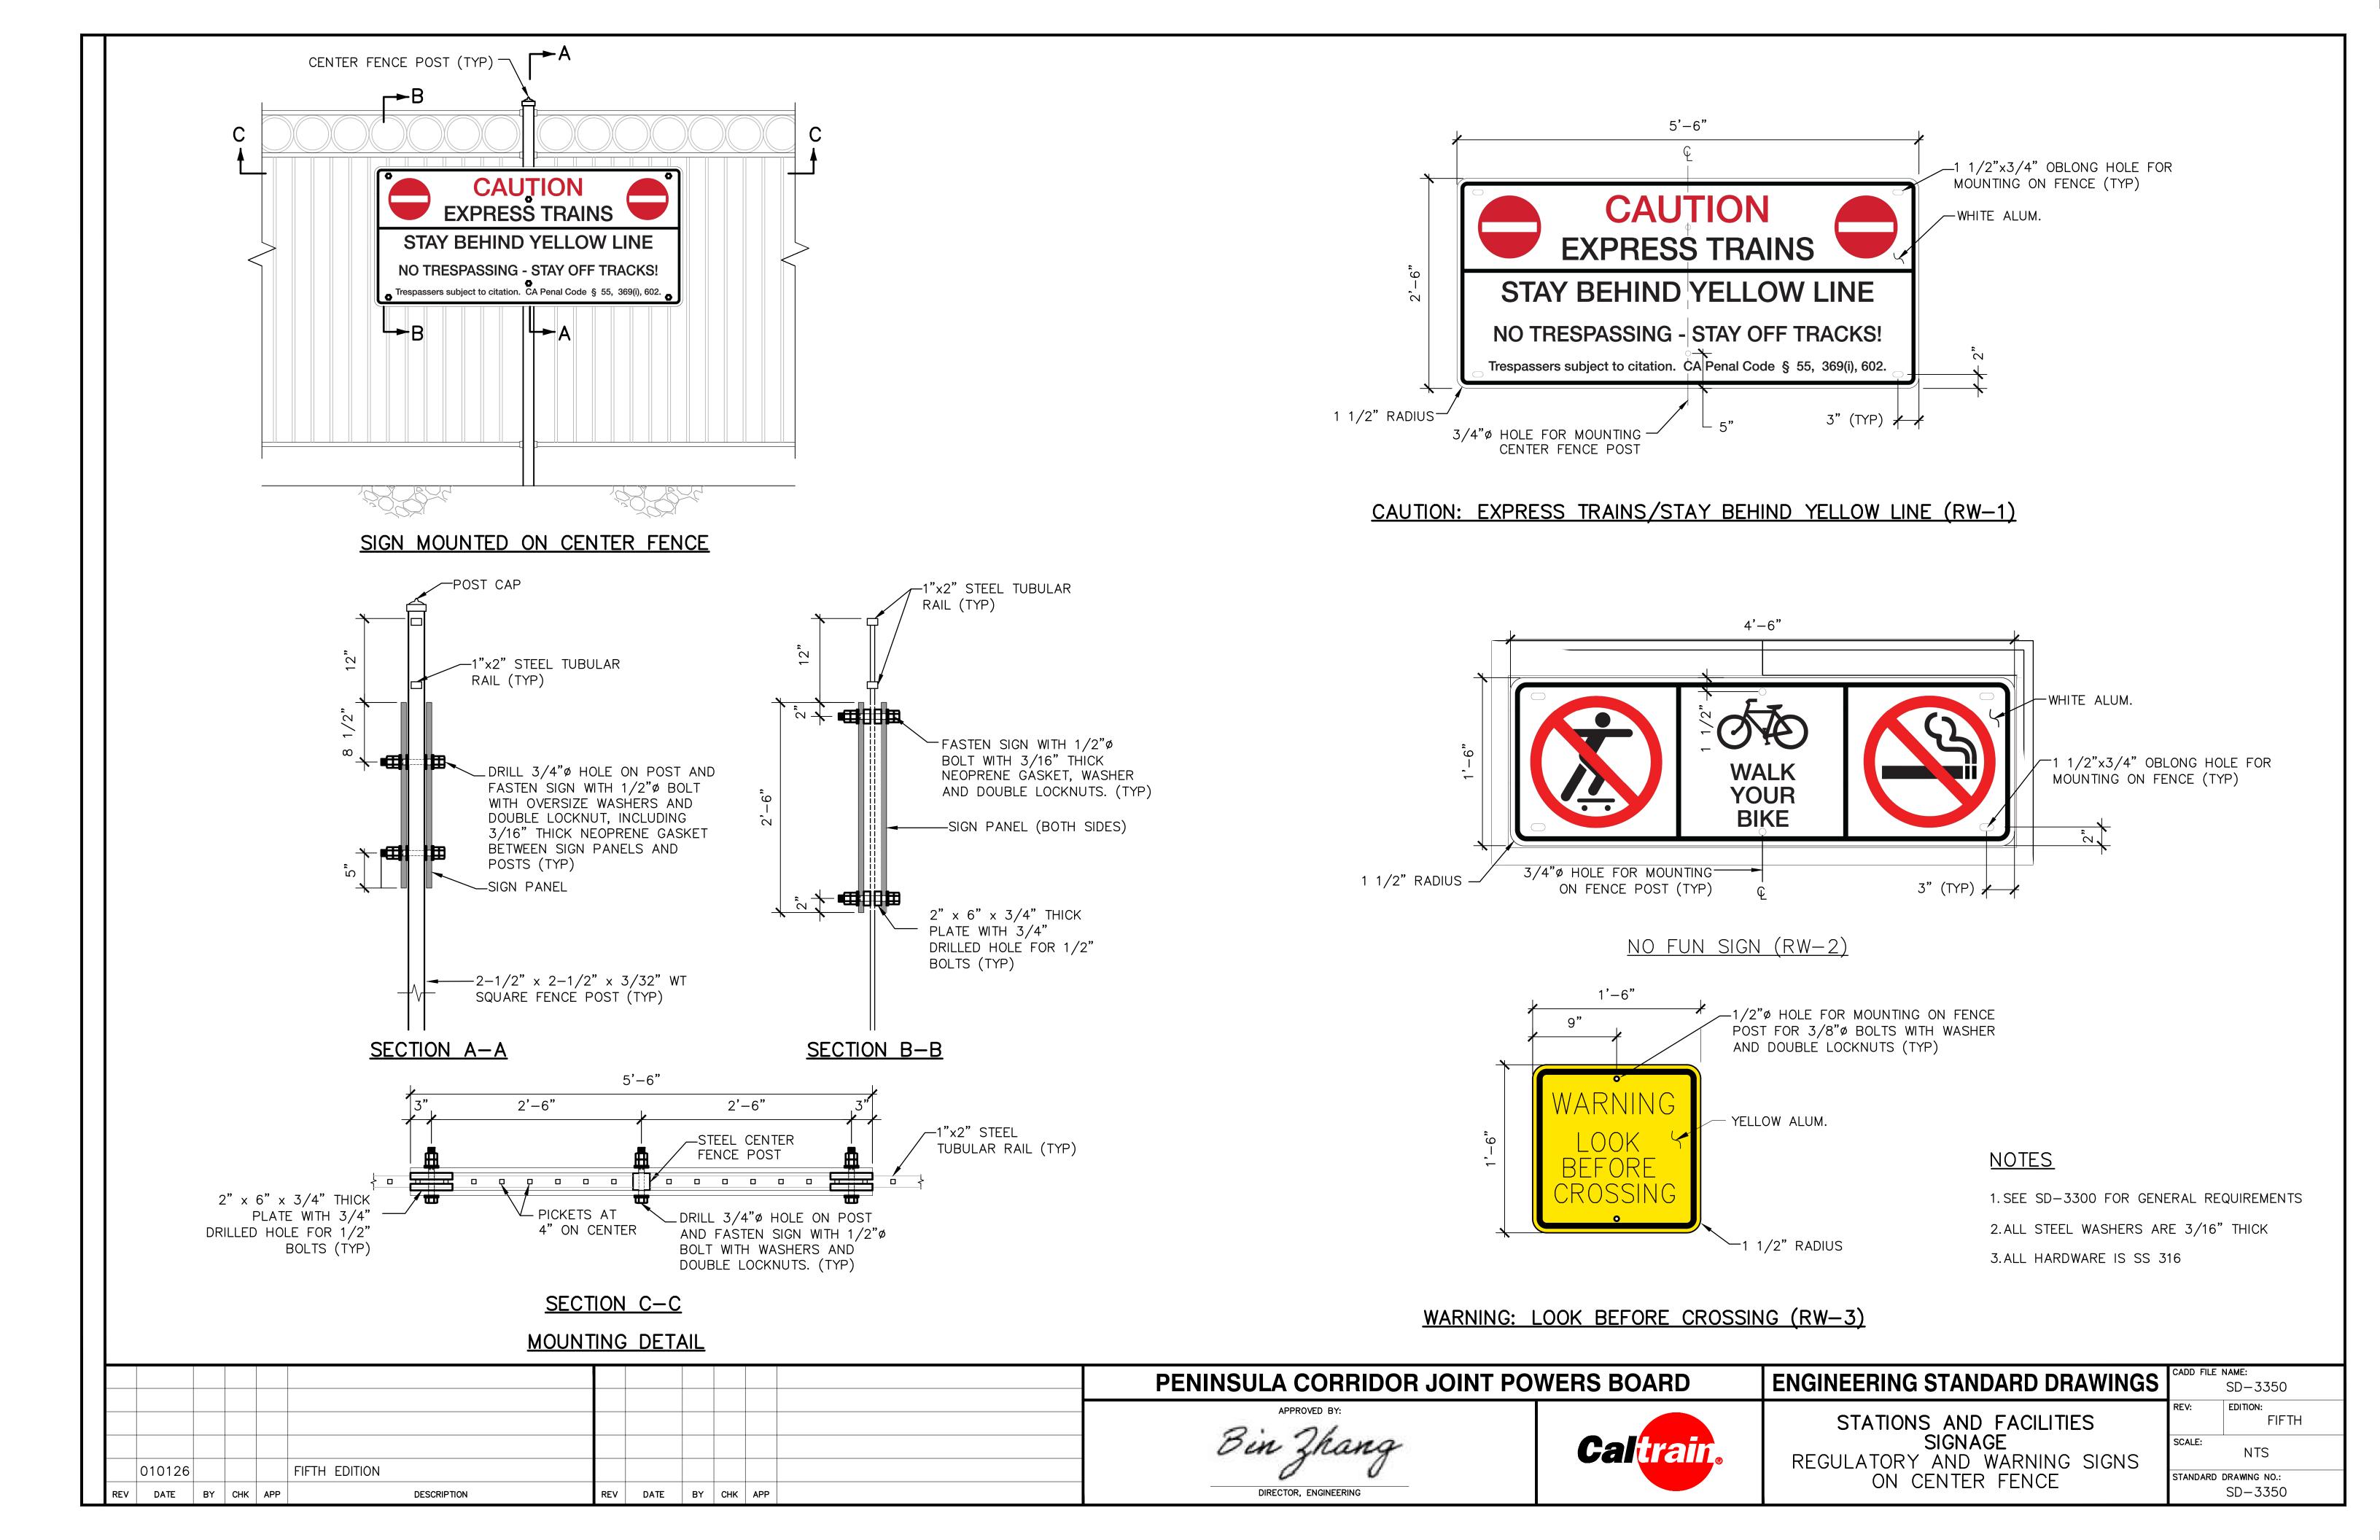

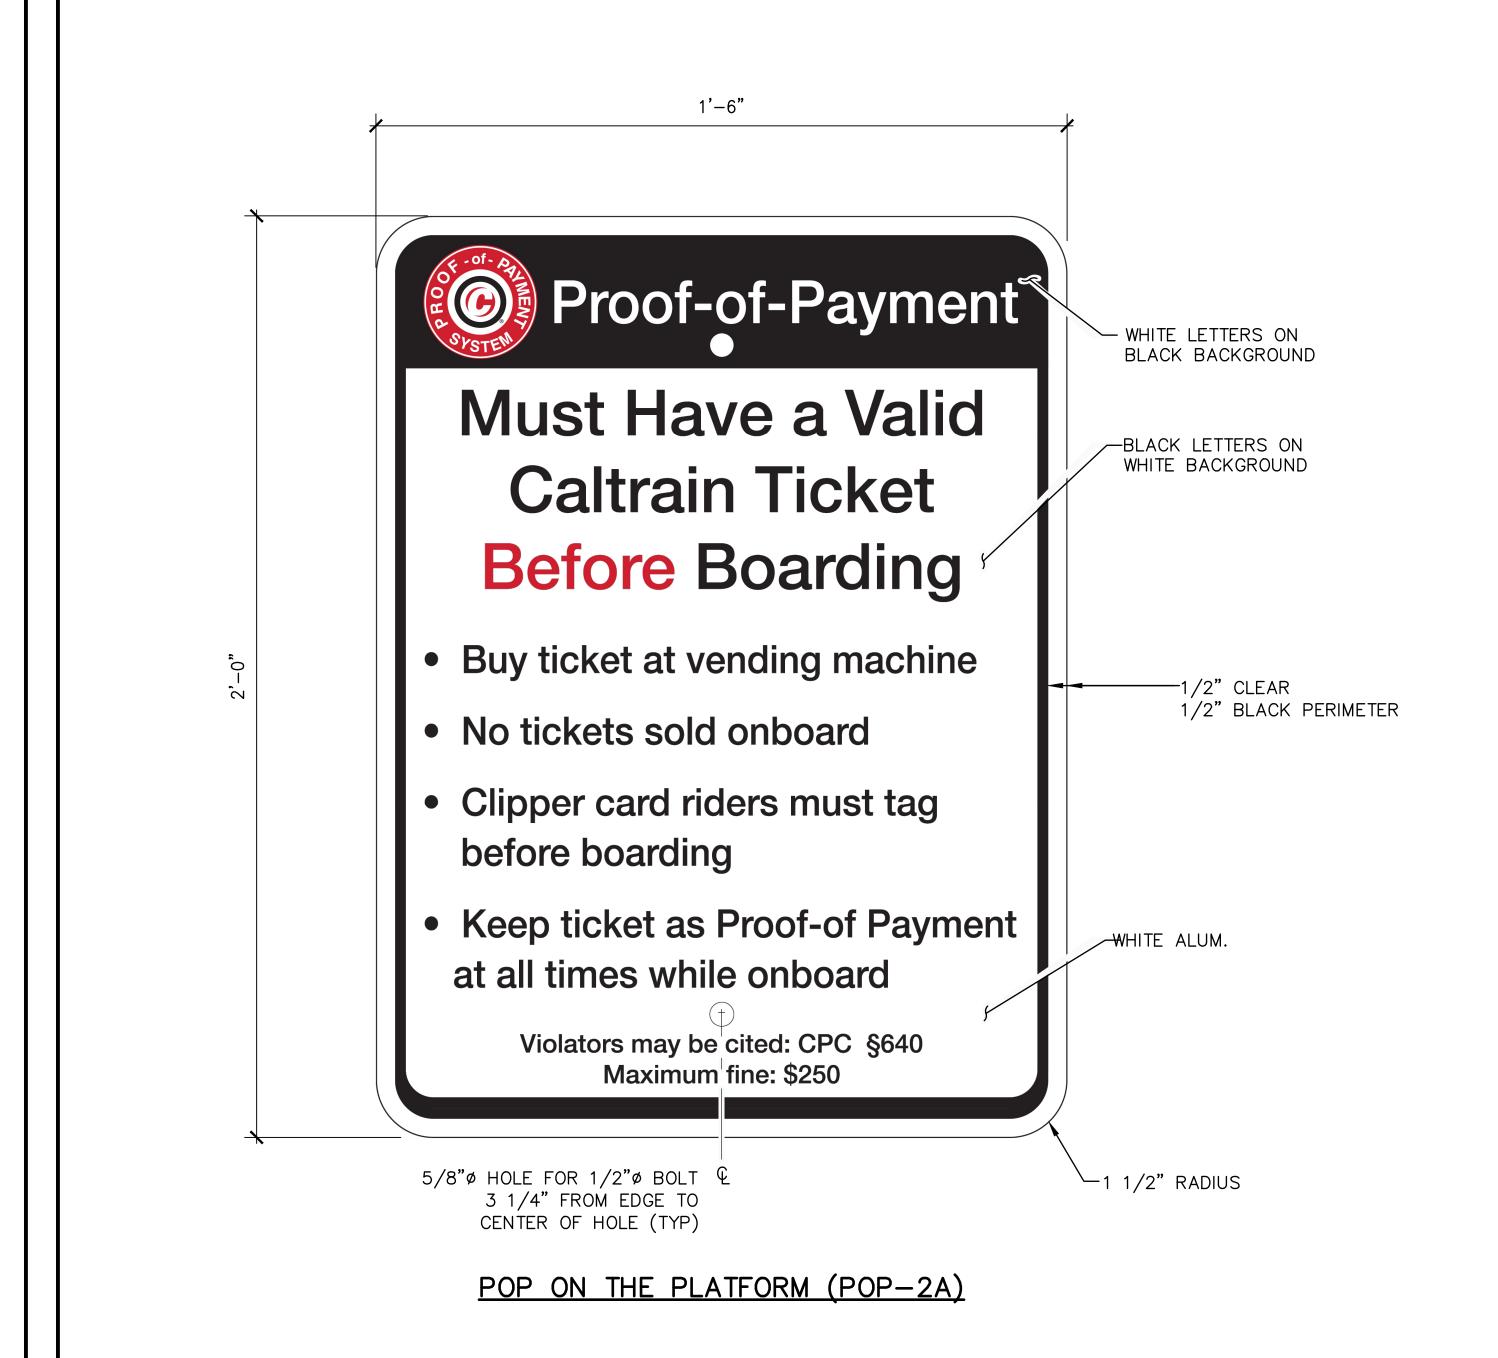





1. SEE SD-3300 FOR GENERAL REQUIREMENTS


2.SEE SHEET SD-3307 FOR MOUNTING DETAILS FOR SIGNS ON CENTER FENCE


3. VERIFY FINE AMOUNT PRIOR TO PRODUCTION

		PENINSULA CORRIDOR JOINT P	OWERS BOARD	ENGINEERING STANDARD DRAWINGS	cadd file name: SD-3351
		Bin Zhang	Calivair	STATIONS AND FACILITIES SIGNAGE	REV: EDITION: FIFTH SCALE:
010126 FIFTH EDITION REV DATE BY CHK APP DESCRIPTION	REV DATE BY CHK APP	Director, Engineering	Galuali	PROOF-OF-PAYMENT SIGNS	NTS STANDARD DRAWING NO.: SD-3351

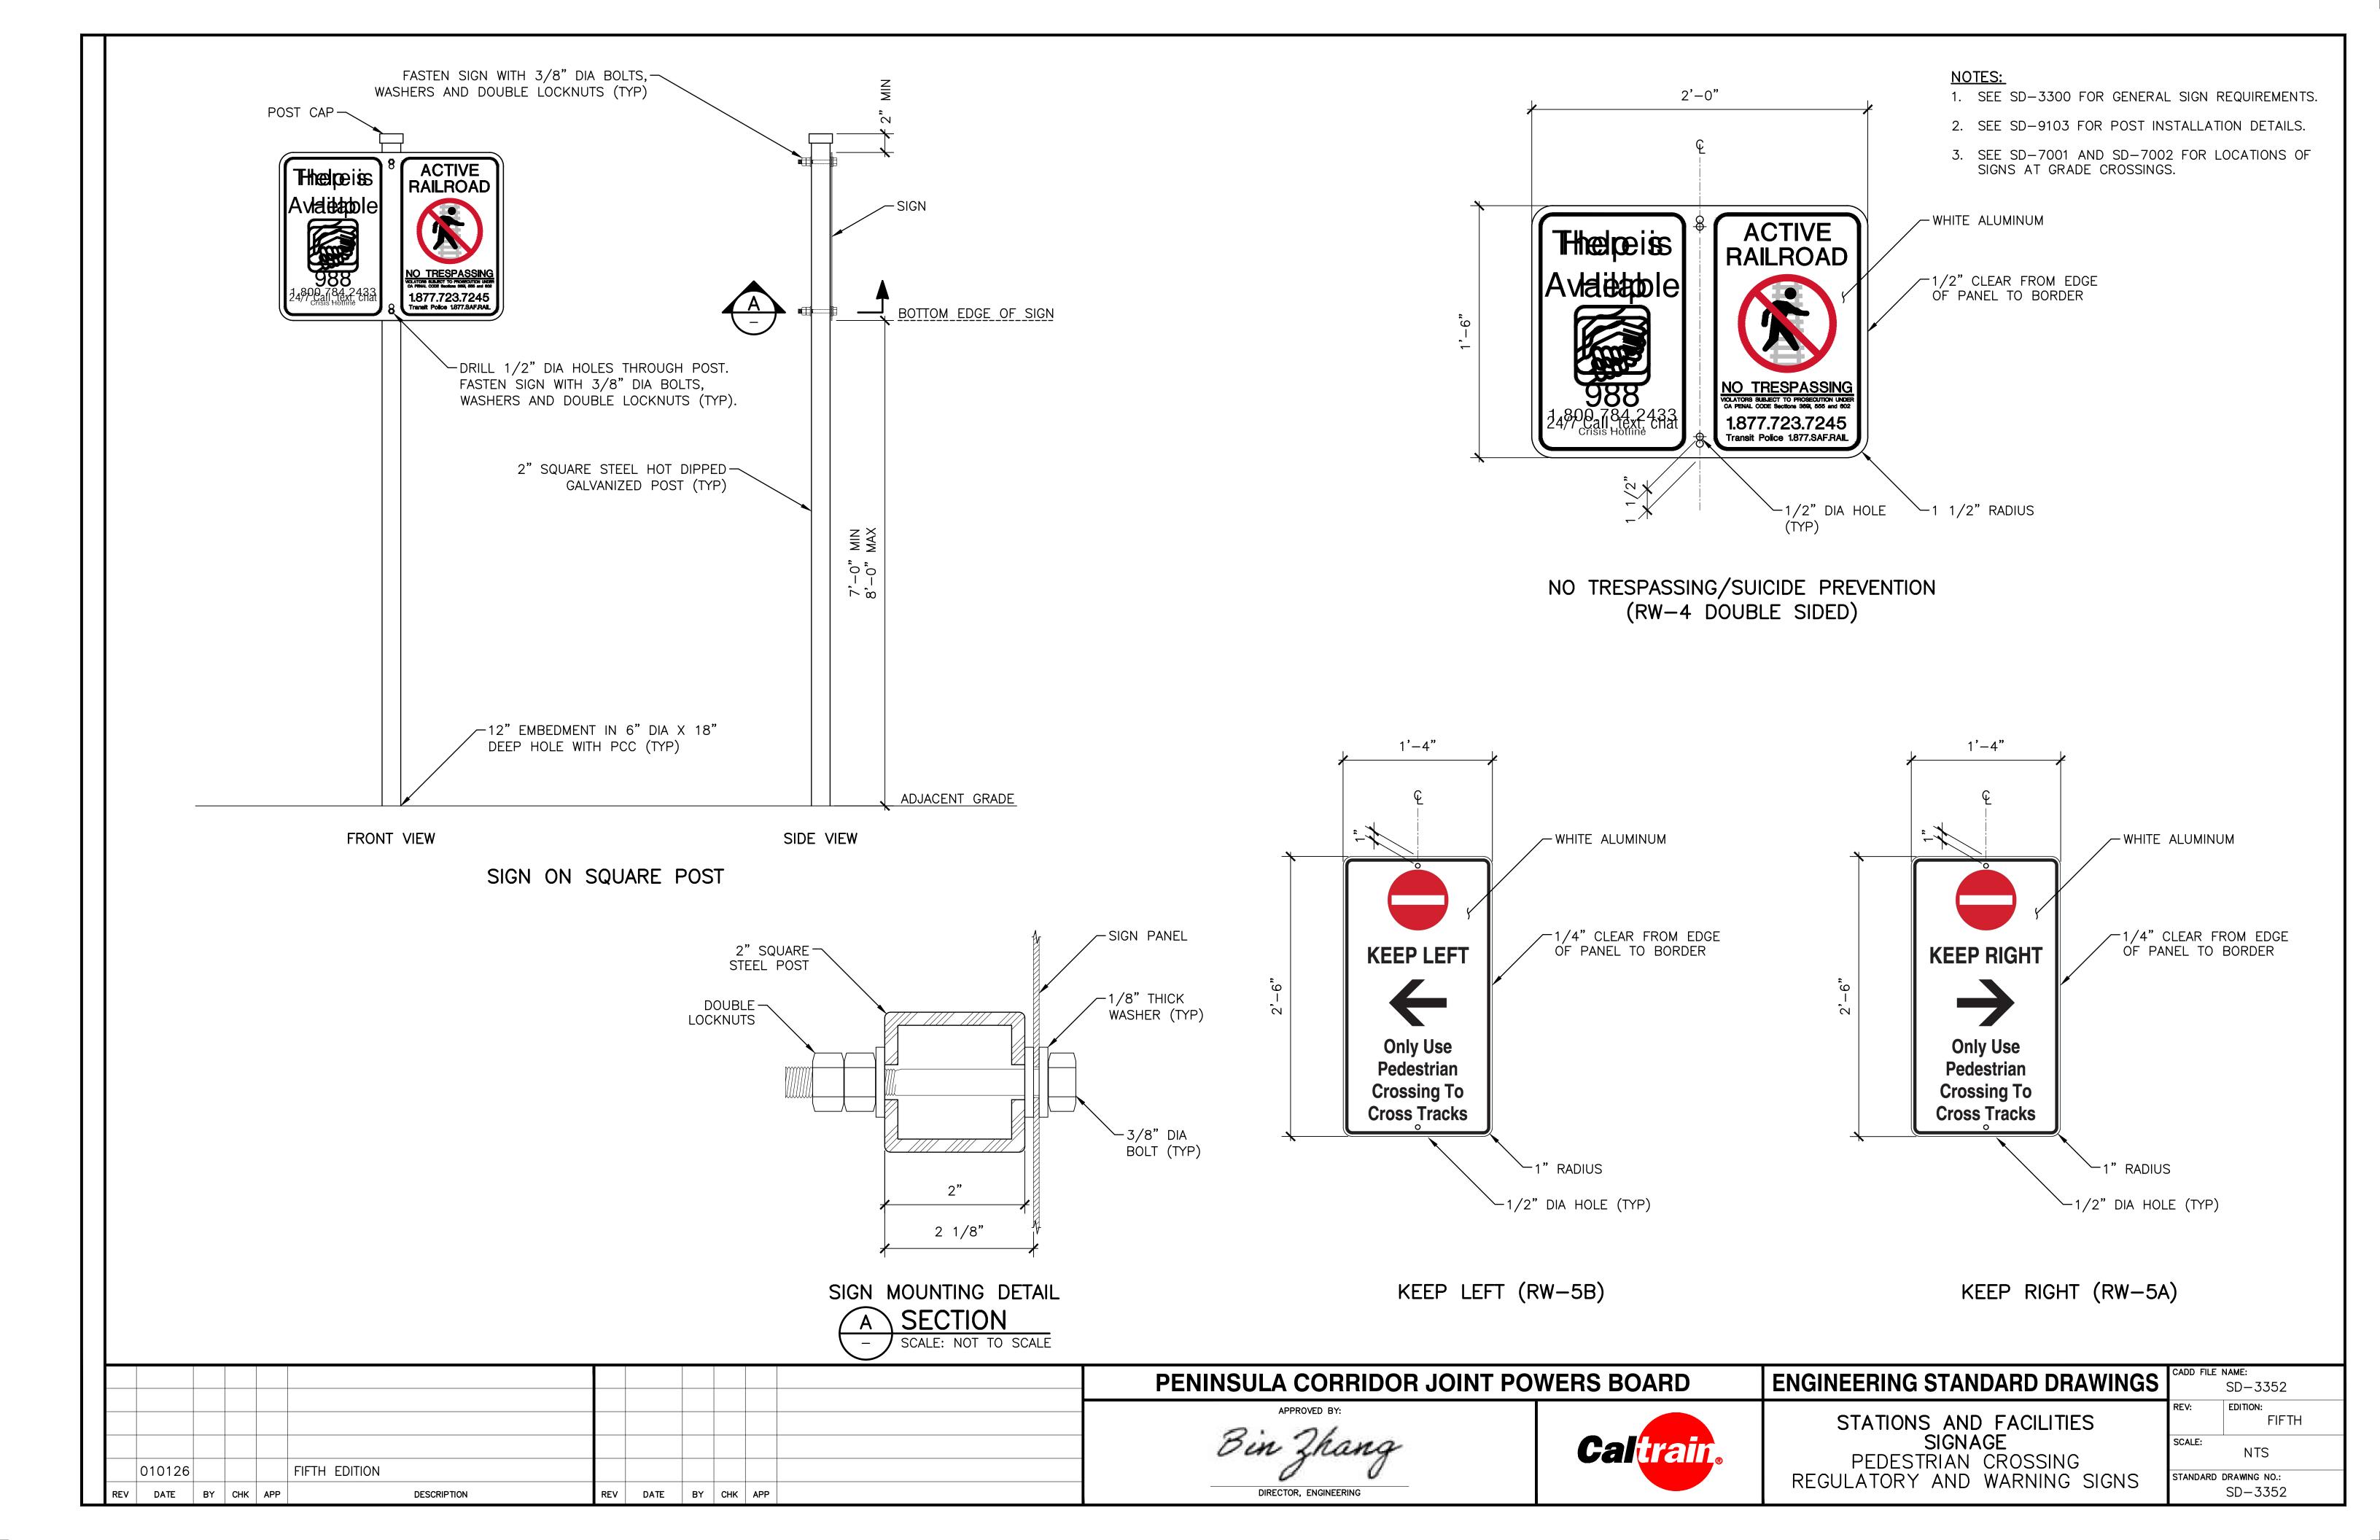

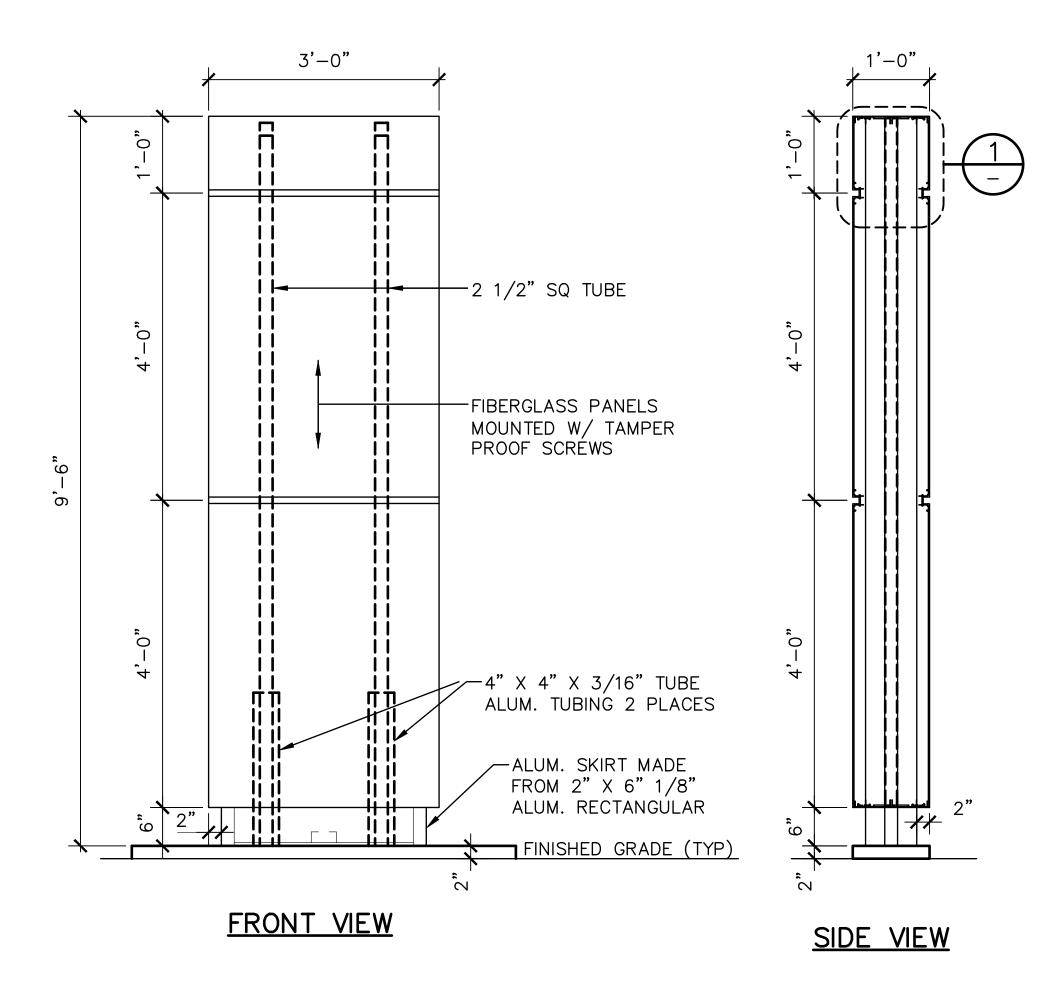

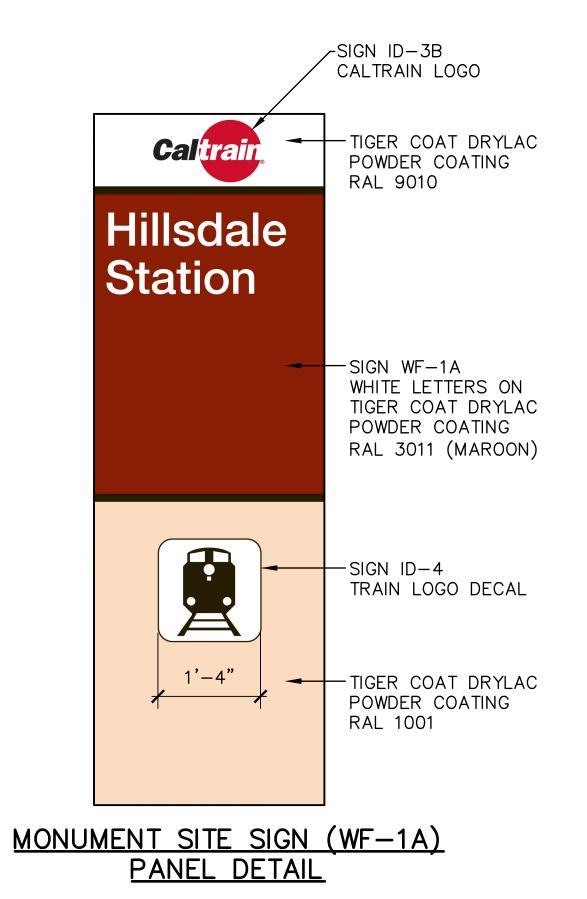

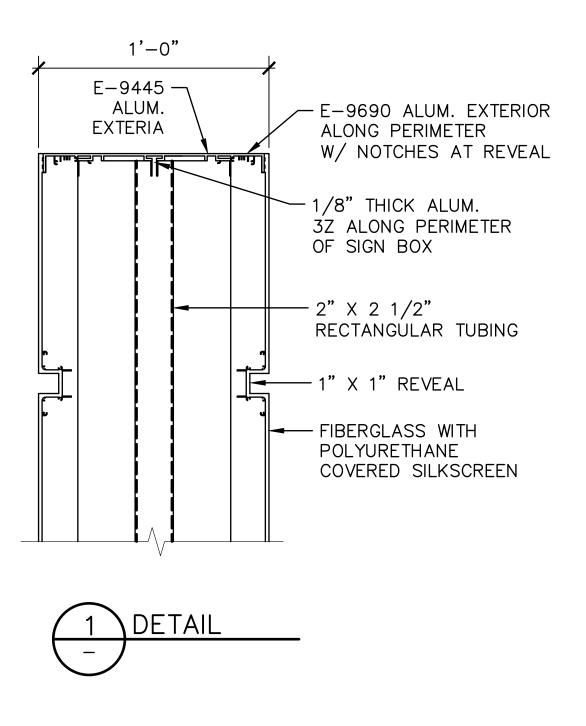



MONUMENT STATION SITE SIGN

NOTE:


SEE SD-3300 FOR GENERAL SIGNAGE REQUIREMENTS.

				PENINSULA CORRIDOR JOINT PO	WERS BOARD	ENGINEERING STANDARD DRAWINGS	cadd file name: SD-3360
010126 REV DATE BY CH	FIFTH EDITION K APP DESCRIPTION	REV DATE BY	CHK APP	Bin Zhang DIRECTOR, ENGINEERING	Caltrain	MONUMENT STATION SITE SIGN	REV: EDITION: FIFTH SCALE: NTS STANDARD DRAWING NO.: SD-3360

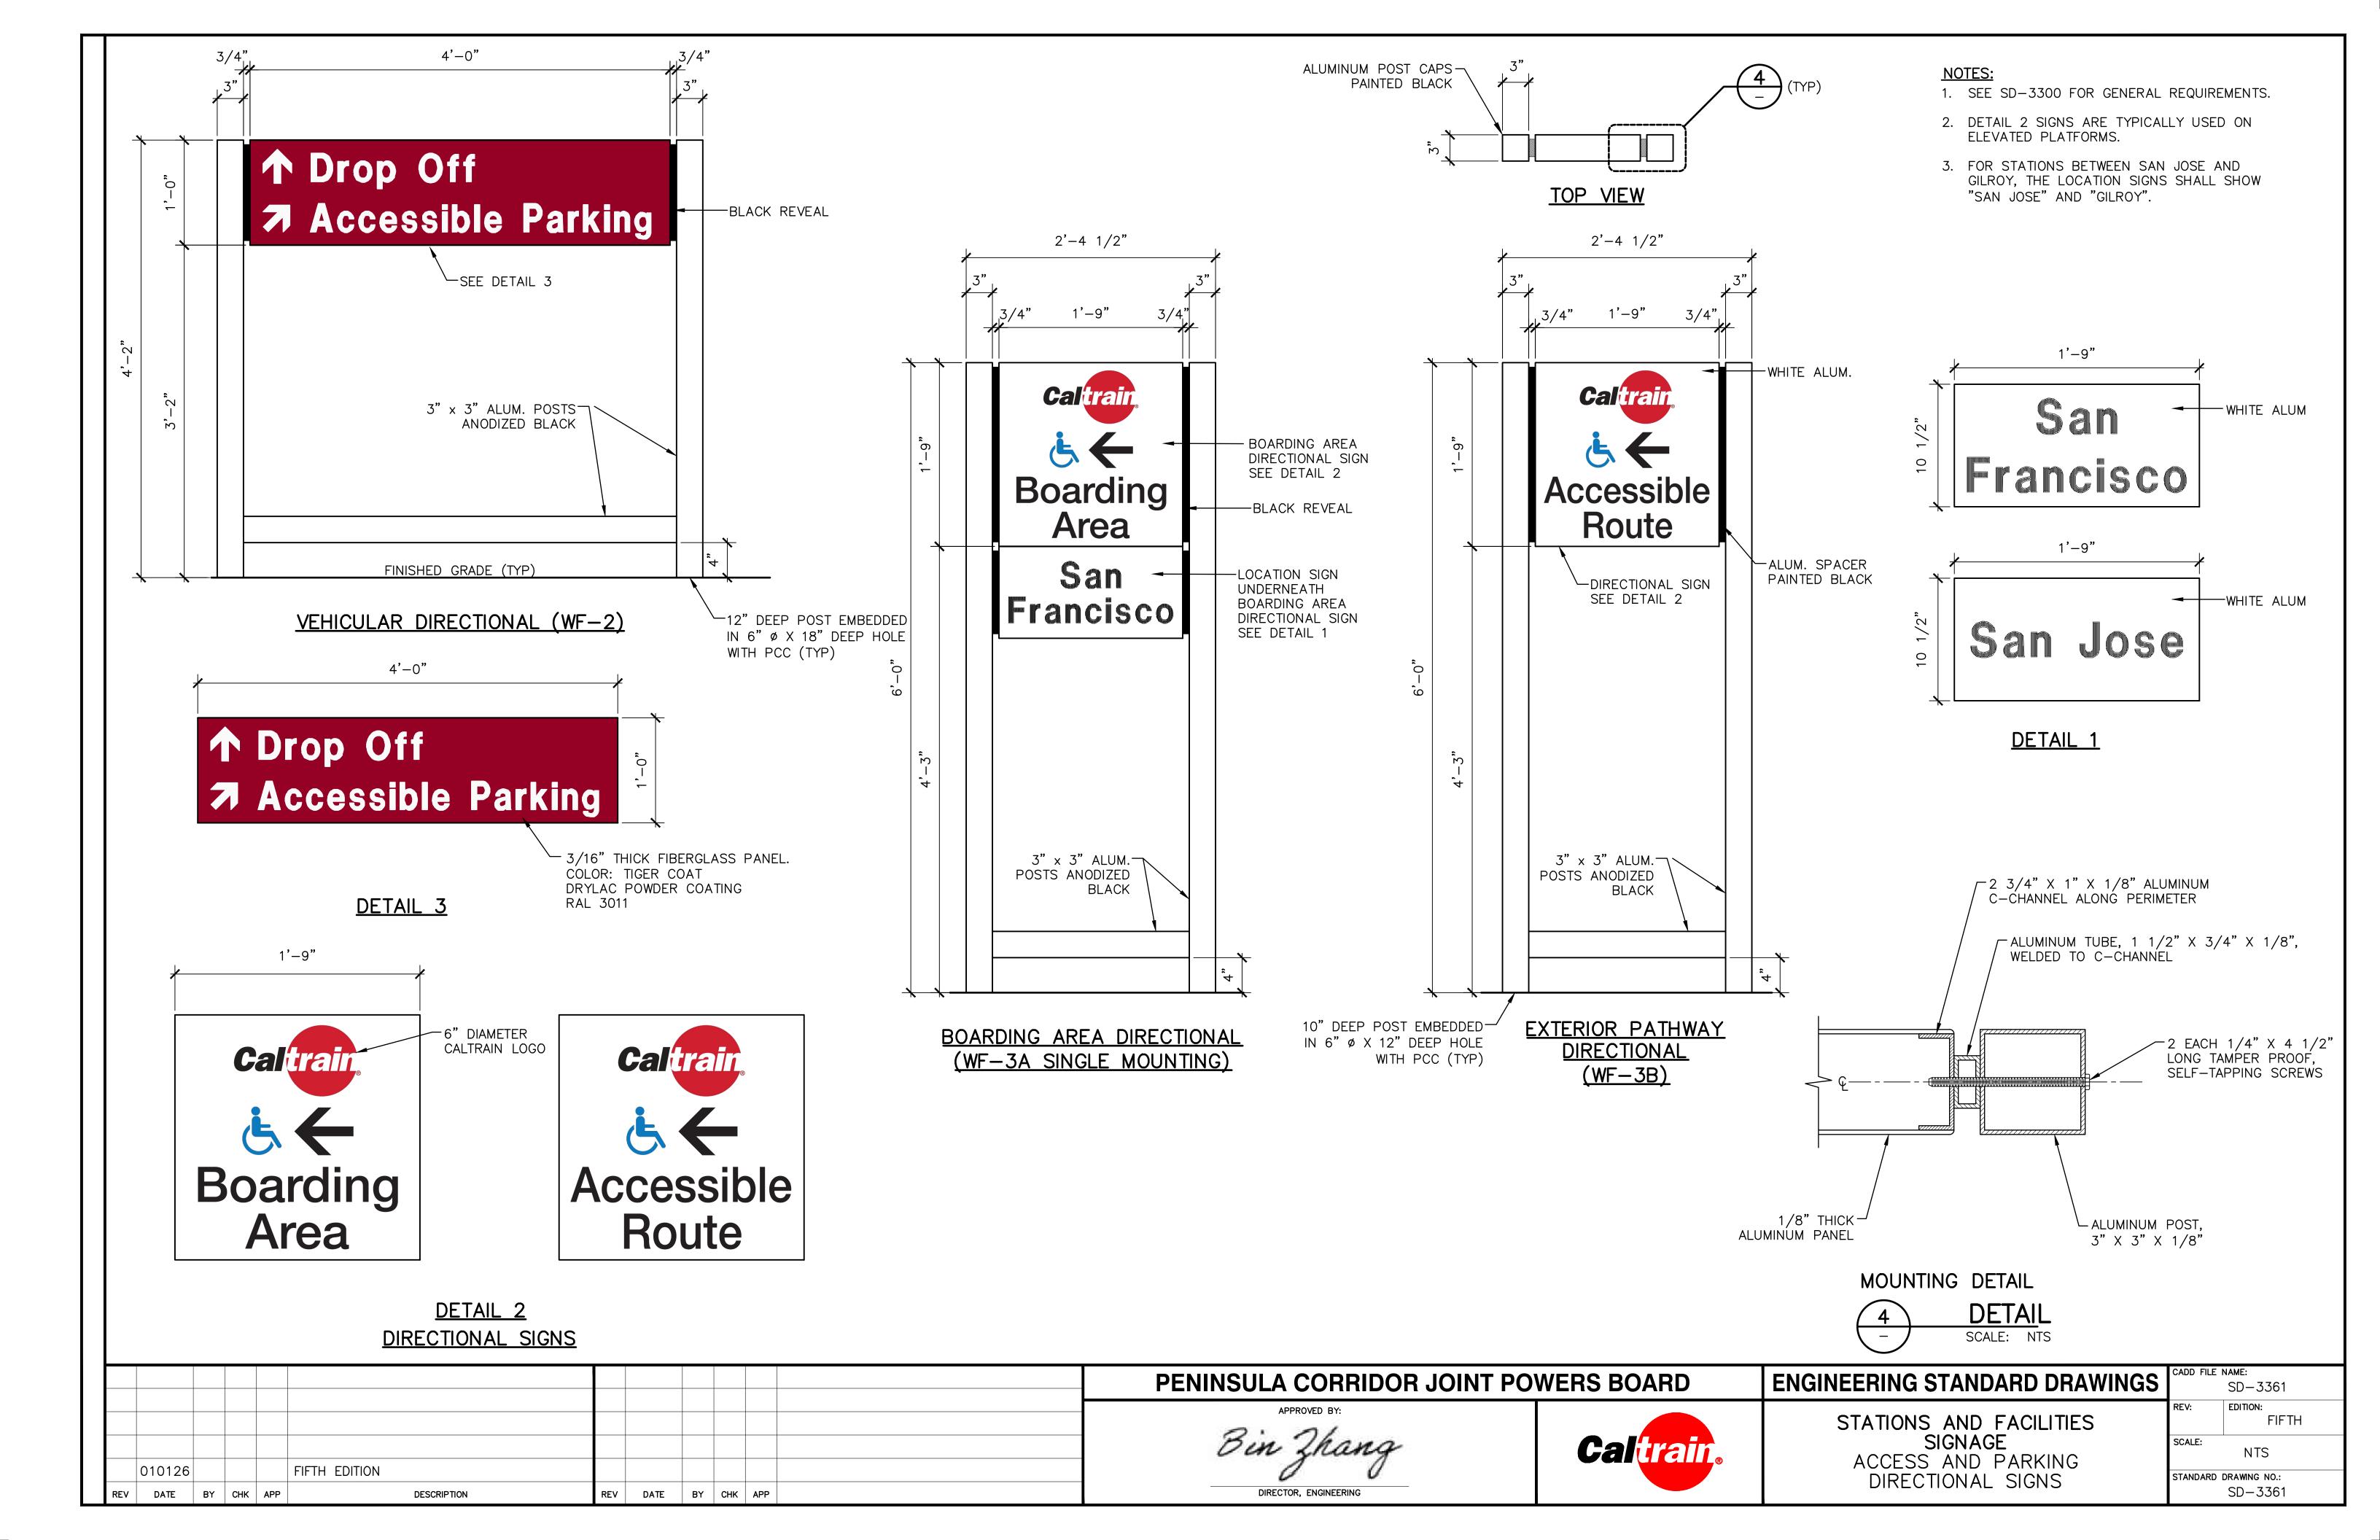

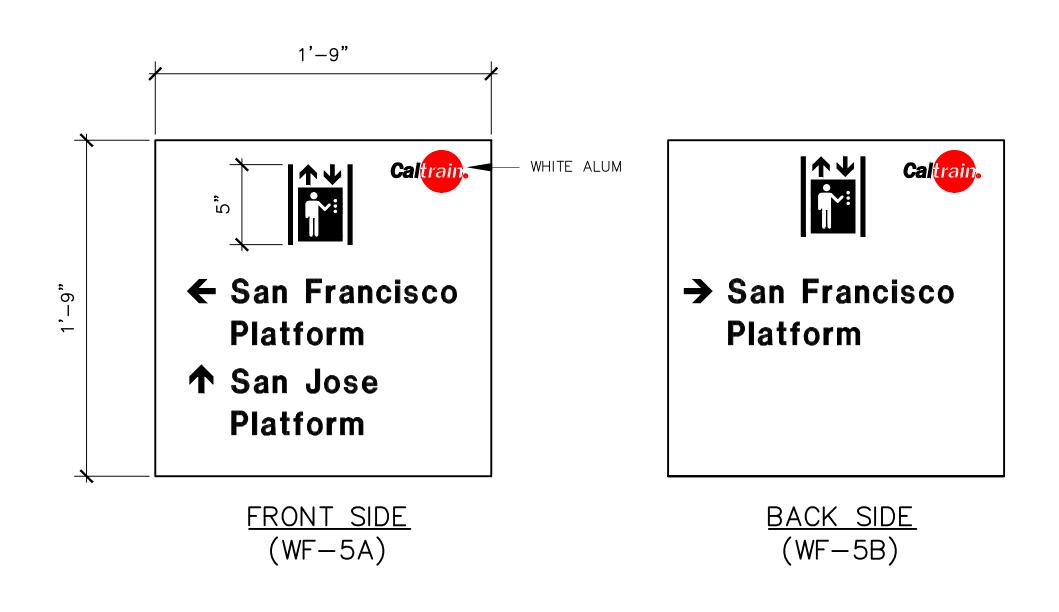

ELEVATOR WAYFINDING SIGN

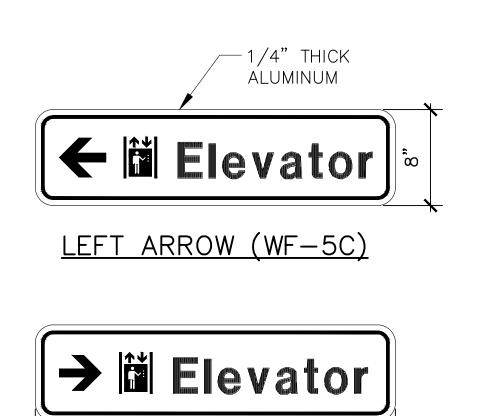


RIGHT ARROW (WF-5D)

2'-6"

ELEVATOR WAYFINDING


NOTES:


- 1. SEE SD-3300 FOR GENERAL REQUIREMENTS
- 2. ELEVATOR WAYFINDING SIGN SHALL BE MOUNTED AS SHOWN ON THE DRAWINGS
- 3. STATION IDENTIFIER ON OVERPASS SHALL BE MOUNTED USING STUD MOUNTS OF 1/2" LONG SPACERS
- 4. FOR STATIONS BETWEEN SAN JOSE AND GILROY, THE WAYFINDING SIGNS SHALL SHOW "SAN JOSE" AND "GILROY"

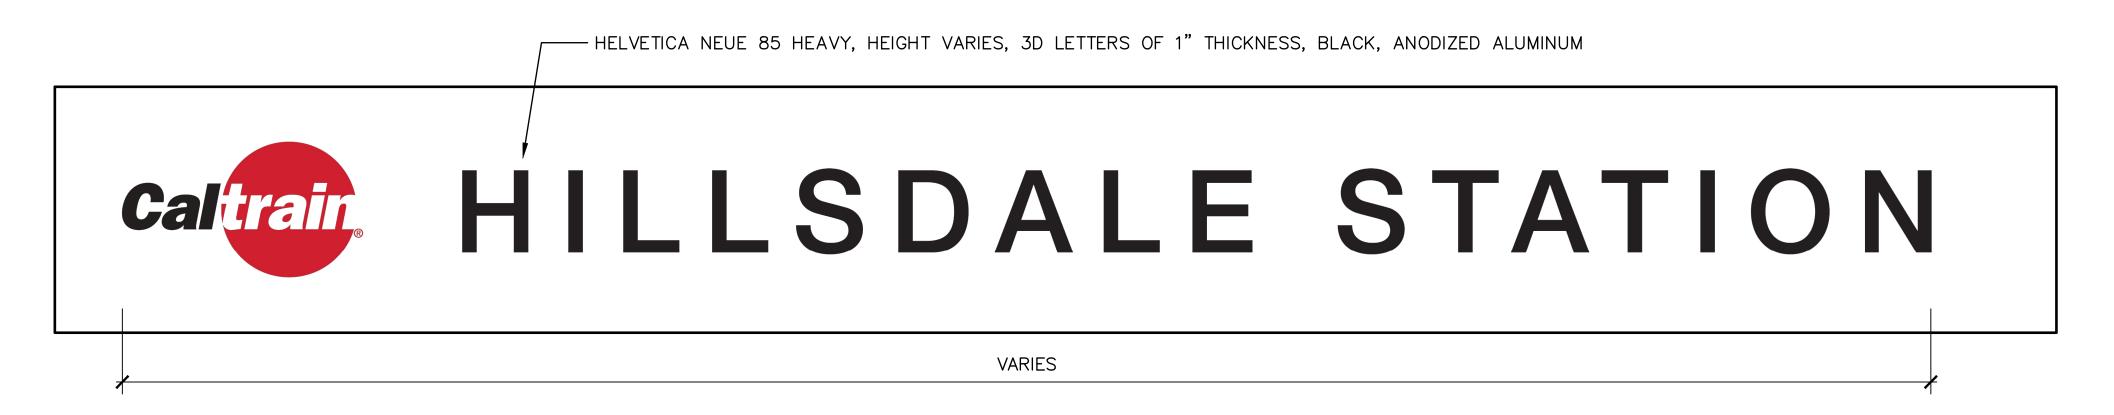

STATION IDENTIFIER ON OVERPASS (WF-1B)


						PENINSULA CORRIDOR JOINT PO	WERS BOARD	ENGINEERING STANDARD DRAWINGS	cadd file name: SD-3362
						Bin Zhang	Calivate	STATIONS AND FACILITIES SIGNAGE	REV: EDITION: FIFTH SCALE: NTS
O1012	FIFTH EDITION	DESCRIPTION	REV DATE	BY CHK	APP	DIRECTOR, ENGINEERING		WAYFINDING SIGNS	STANDARD DRAWING NO.: SD-3362

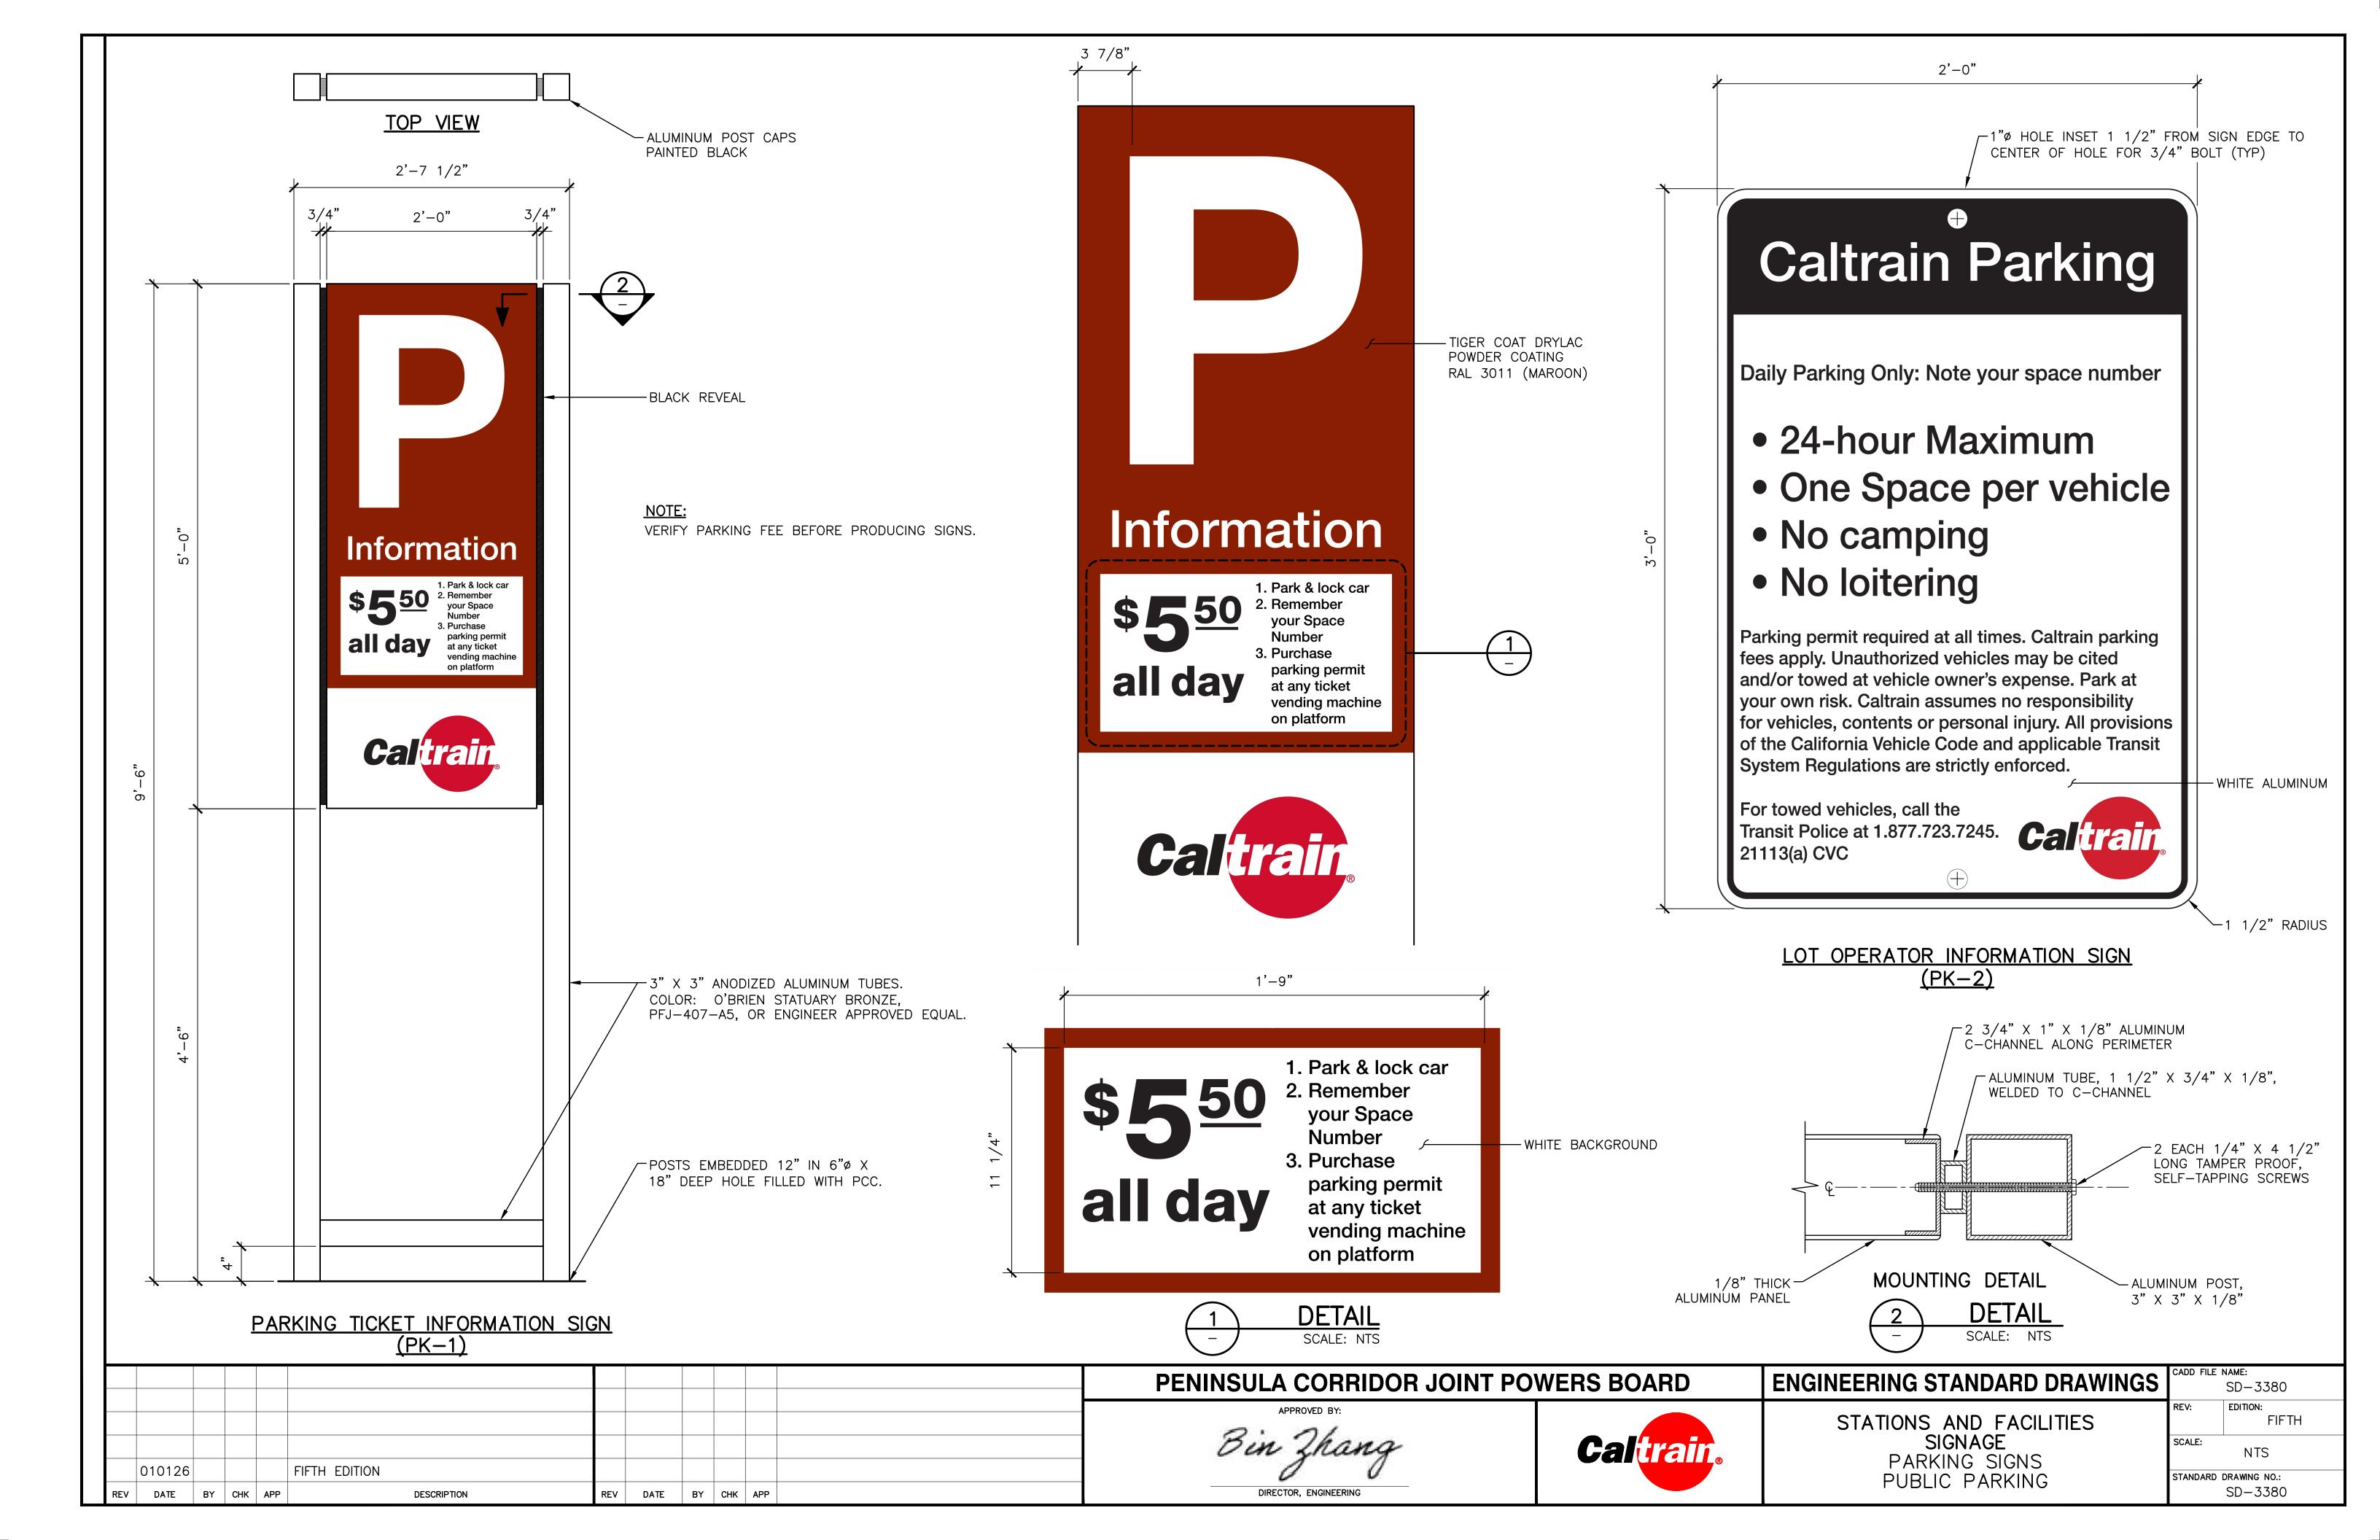

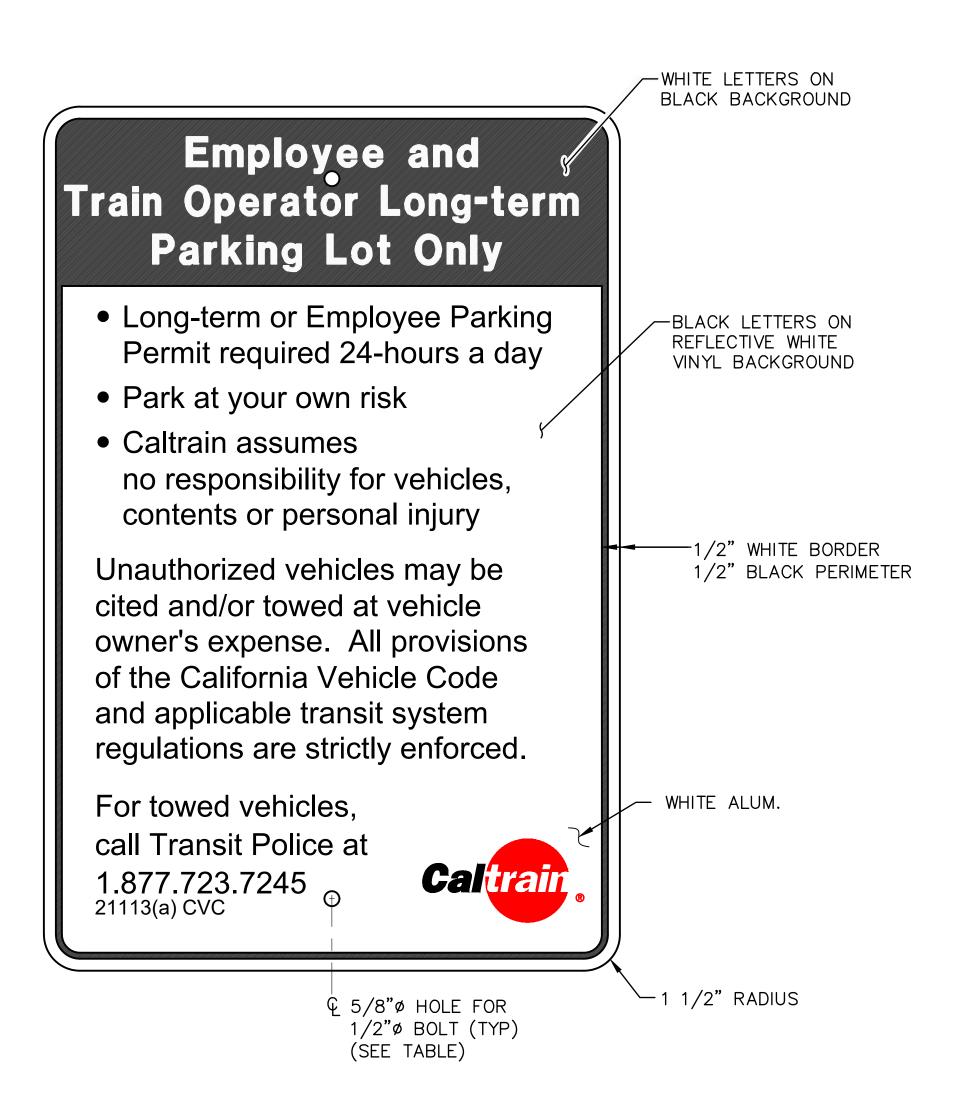

EMPLOYEE AND TRAIN OPERATOR LONG TERM PARKING LOT ONLY (PK-3A, PK3B)

			DISTANCE FROM EDGE	FONT	SIZE	CALTRAIN	SIGN ID
	WIDTH	HEIGHT	TO CENTER OF HOLE	WHITE LETTERS	BLACK LETTERS	LOGO	1
TYPE 1	1'-0"	1'-6"	1 1/2"	7"	5 1/2"	21"	PK-3A
TYPF 2	2'-0"	3'-0"	.3"	1'-2"	11"	42"	PK-3B

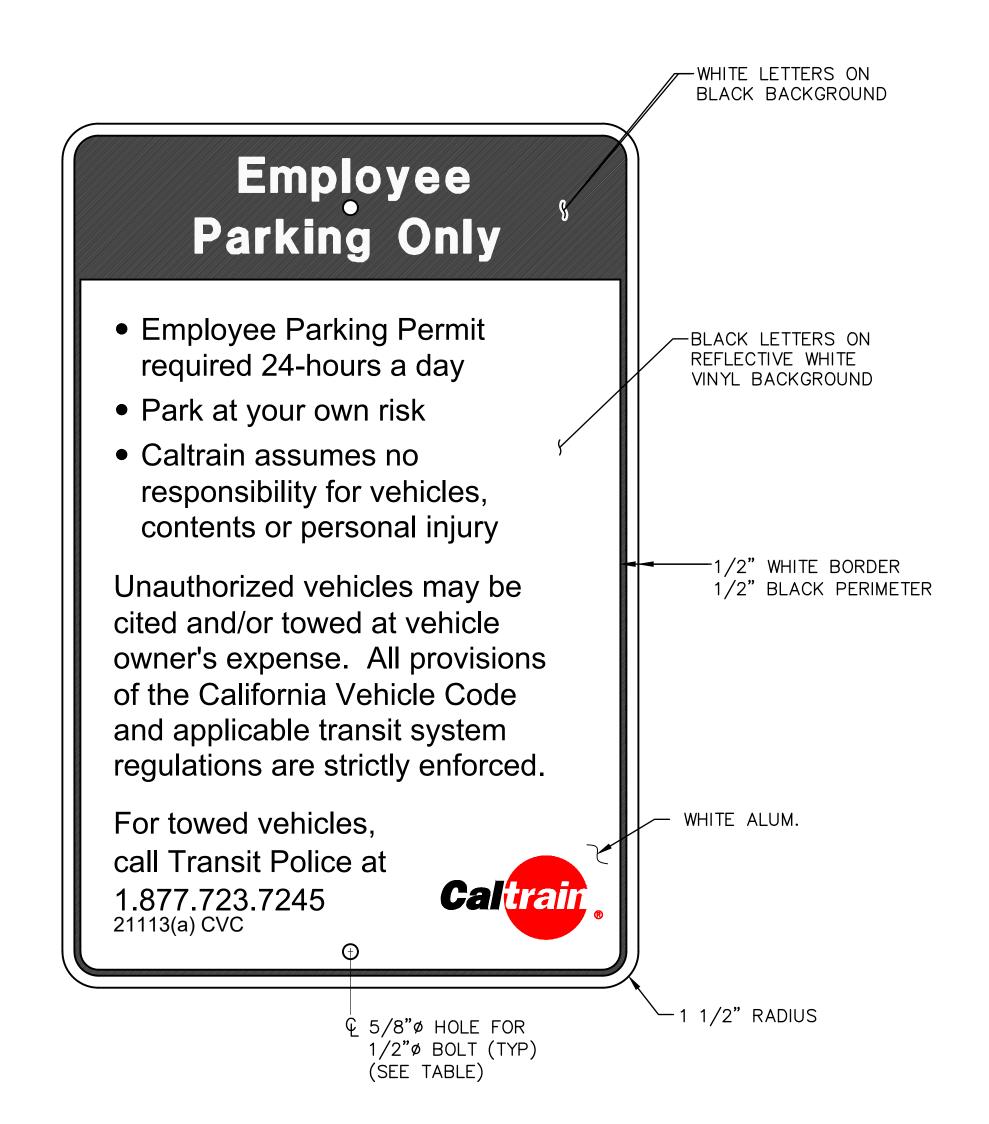


EMPLOYEE PARKING ONLY (PK-4A, PK-4B)


			DISTANCE FROM EDGE	FONT	SIZE	CALTRAIN	SIGN ID
	WIDTH	HEIGHT	TO CENTER OF HOLE	WHITE LETTERS	BLACK LETTERS	LOGO	
TYPE 1	1'-0"	1'-6"	1 3/4"	7"	5 1/2"	21"	PK-4A
TYPE 2	2'-0"	3'-0"	3 1/2"	1'-2"	11"	42"	PK-4B


NOTES:

1. SEE SD-3300 FOR GENERAL REQUIREMENTS2.MOUNTING HARDWARE: SS 316 TAMPER PROOF3. AMTRAK SHOWN FOR ILLUSTRATION ONLY


-								PENINSULA CORRIDOR JOINT PO	WERS BOARD	ENGINEERING STANDARD DRAWINGS	cadd file name: SD-3381
								Bin Zhang	Calivair	STATIONS AND FACILITIES SIGNAGE	REV: EDITION: FIFTH SCALE: NTS
	0126 DATE	BY CHK	FIFTH EDITION	DESCRIPTION	REV DATE	BY CH	APP	DIRECTOR, ENGINEERING		PARKING SIGNS EMPLOYEE PARKING	STANDARD DRAWING NO.: SD-3381

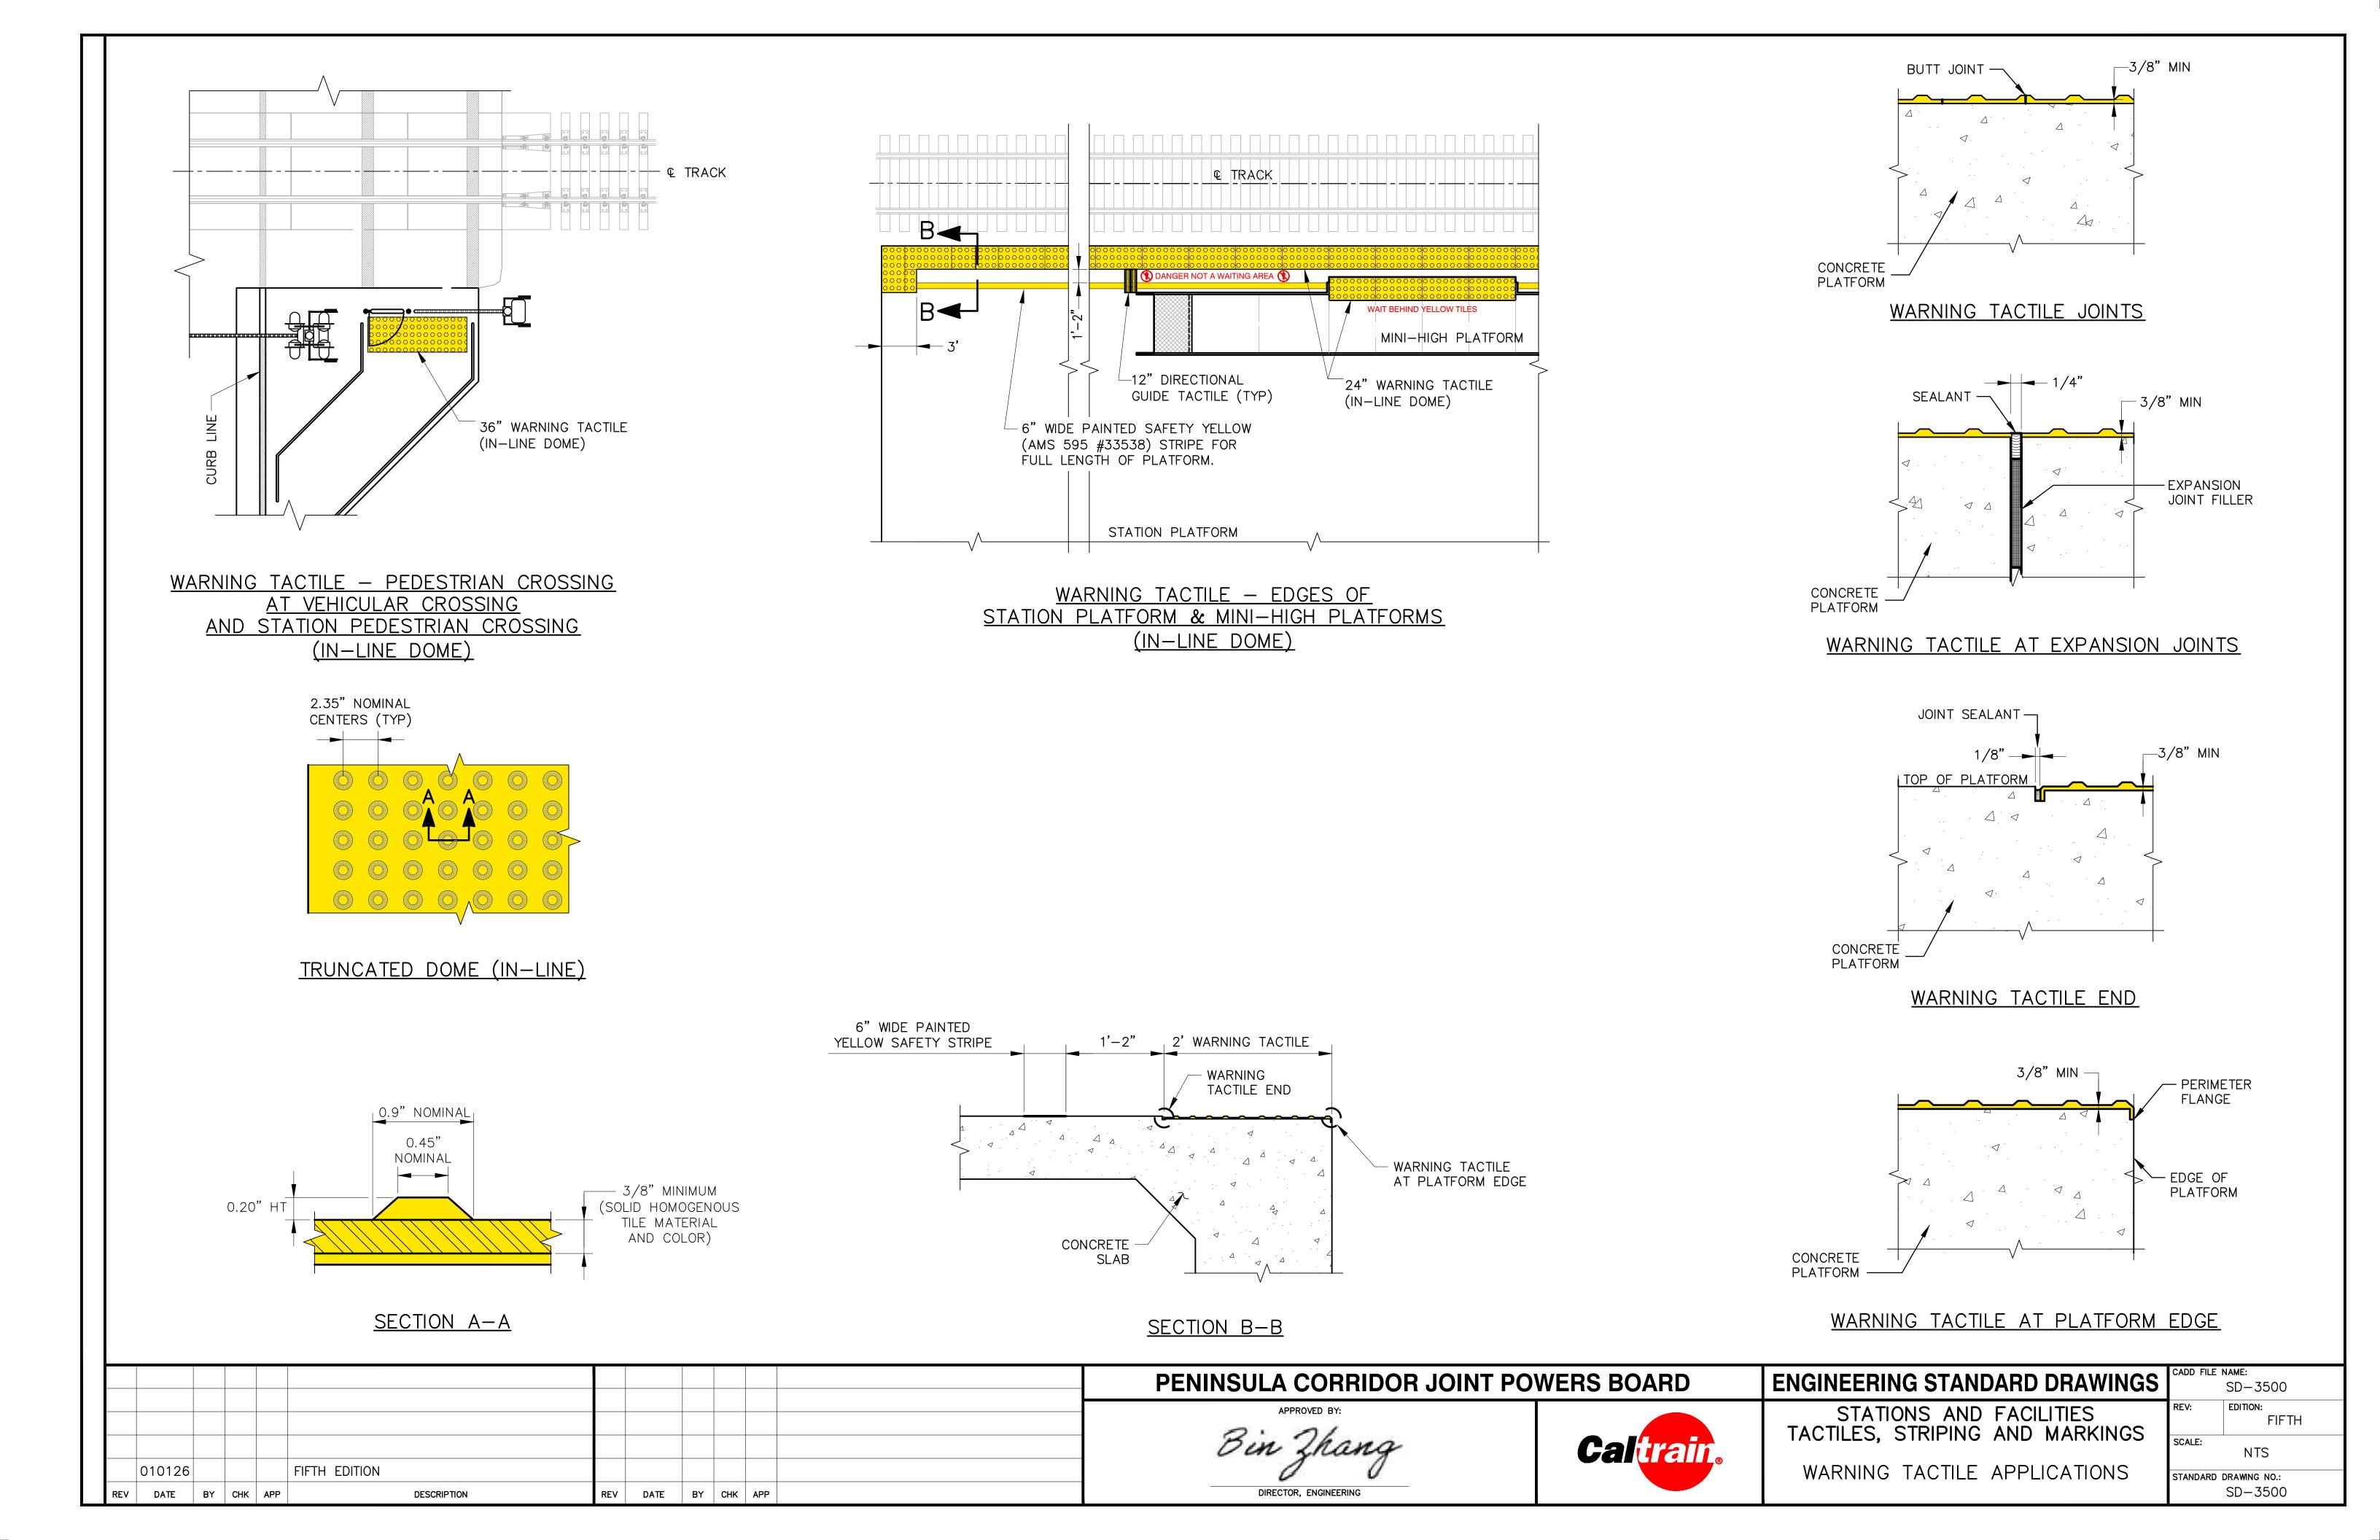


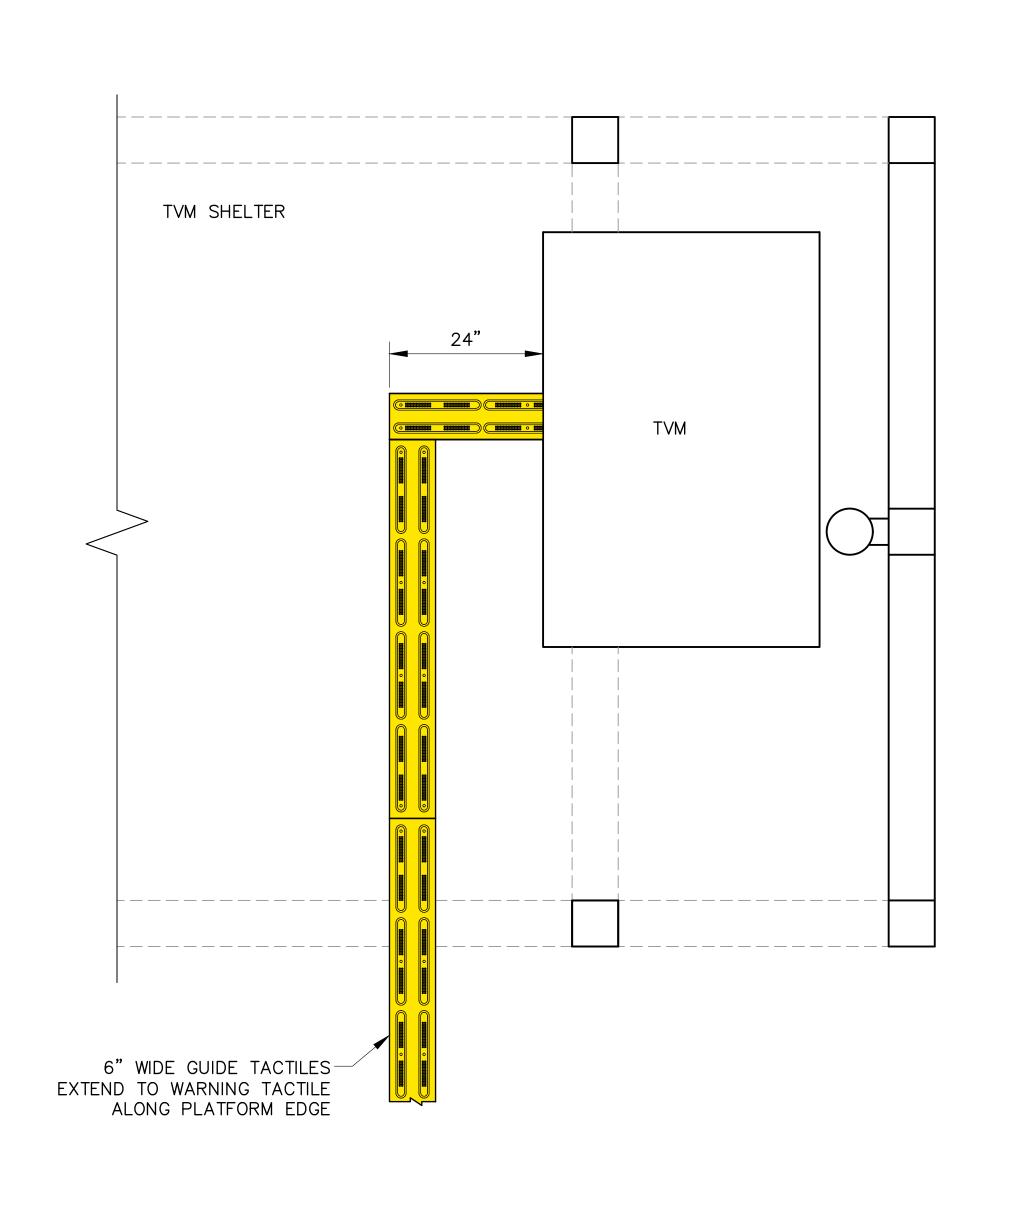


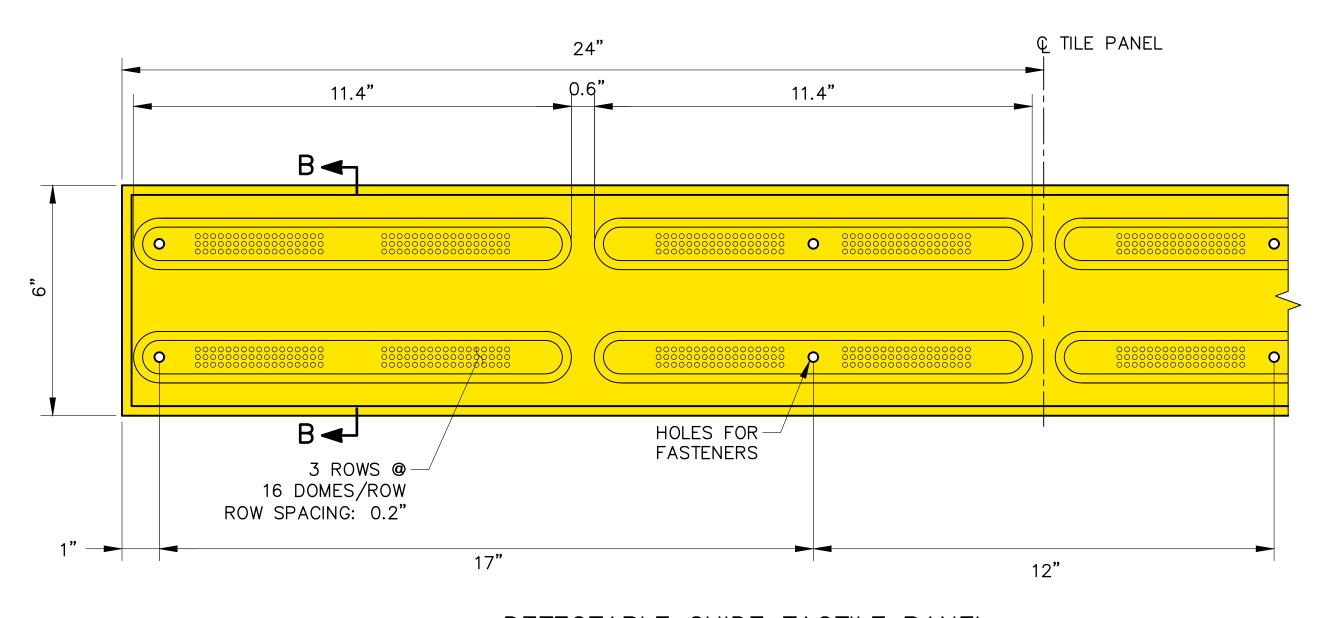

DETECTABLE GUIDE TACTILE PANEL

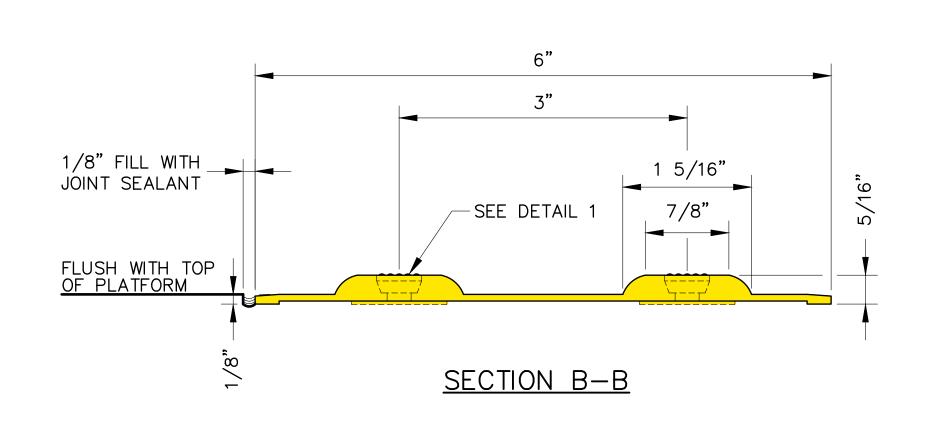

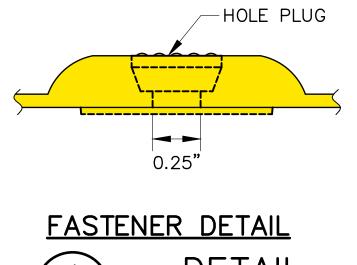

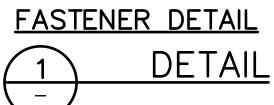

DIMENSIONS ARE NOMINAL. SUBMIT SAMPLES FOR ENGINEER'S APPROVAL.

	PENINSULA CORRIDOR JOINT PO	WERS BOARD	ENGINEERING STANDARD DRAWINGS	CADD FILE NAME: SD-3501
	Bin Zhang DIRECTOR, ENGINEERING	Caltrain	STATIONS AND FACILITIES TACTILES, STRIPING AND MARKINGS DETECTABLE GUIDE TACTILES	REV: EDITION: FIFTH SCALE: NTS STANDARD DRAWING NO.: SD-3501

